

8 4 0 8 Miles

### Reference

Base map comprised of ESRI StreetMap.

### Vicinity Map

### Caminada Bay Bridge

Coastal Use Permit

SPN 064-01-0040/FAP BR-52-01(001)

Jefferson Parish, Louisiana

Louisiana

Department of Transportation and Development




PROVIDENCE

Drawn By	LMM	10/13/08
Checked By	DRA	10/13/08
Approved By		

Project Number  
040-007


Drawing Number  
040-007-A423

**1**  
Figure

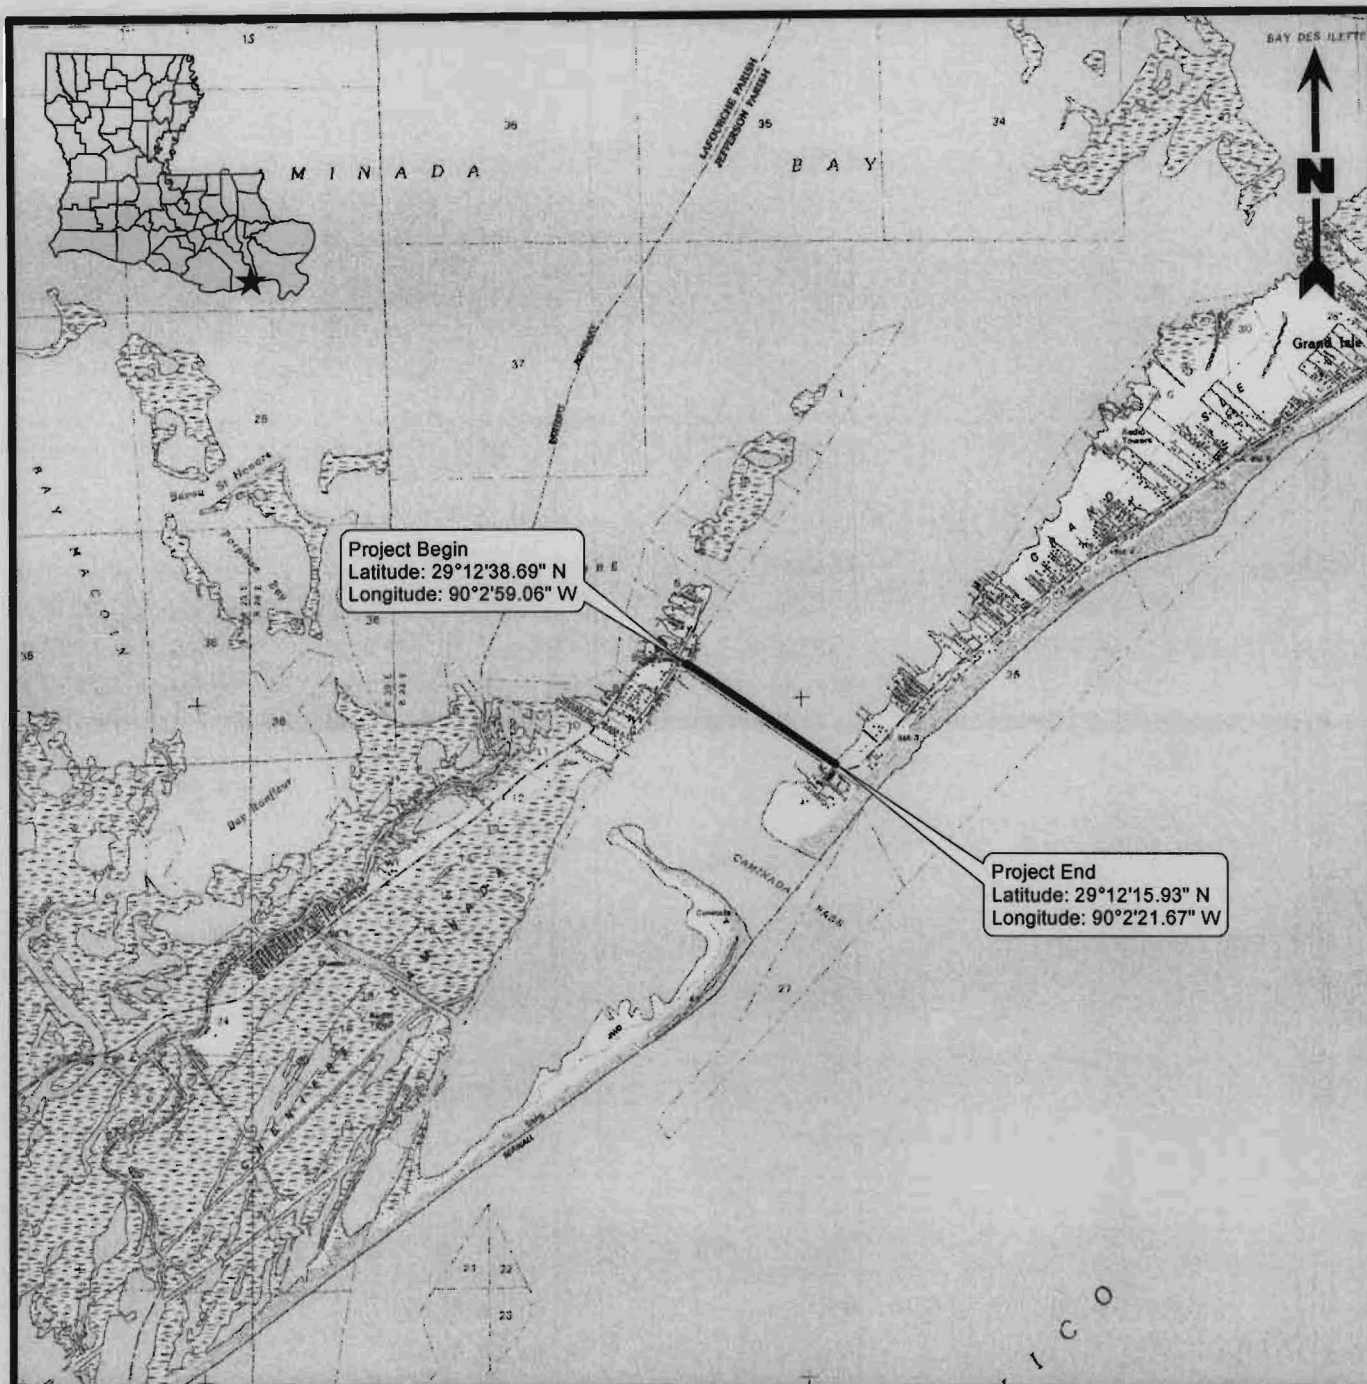

4,000 2,000 0 4,000  
Feet

### Legend

 Project Area (8.62 Acres)

### Reference

Base map comprised of U.S.G.S. 7.5 minute topographic maps, "Barataria Pass, LA" 1993, "Grand Isle, LA" 1973, "Caminada Pass, LA" and "Bay Tambour, LA" 1994.

## Site Location Map

### Caminada Bay Bridge

Coastal Use Permit

SPN 064-01-0040/FAP BR-52-01(001)

Jefferson Parish, Louisiana

Louisiana

Department of Transportation and Development



PROVIDENCE

Drawn By	LMM	09/30/08
Checked By	DRA	09/30/08
Approved By		

Project Number  
040-007

Drawing Number  
040-007-A328

**2**

Figure

**1. Excavated Material**

- a. Construction of the new bridge will consist of the excavation of 59,100 yd<sup>3</sup> of non-vegetated water bottoms.
- b. Removal of the existing bridge will require the excavation of 15,700 yd<sup>3</sup> of non-vegetated water bottoms.
- c. Proposed excavation for maintenance during construction consists of 7,500 yd<sup>3</sup> of non-vegetated water bottoms.
- d. Proposed pile setting for the construction of the new bridge will displace 12,800 yd<sup>3</sup> of non-vegetated water bottoms.

**2. Fill Material**

- a. Dredged material 82,300 yd<sup>3</sup>
- i. Louisiana Department of Transportation and Development (LDOTD) is proposing to place the dredged material on a site owned by the City of Grand Isle. The potential placement site is identified on Figure 8a.
- b. Concrete from the removal of the existing bridge 7,500 yd<sup>3</sup>
- i. Based on relevant law in Section 1805 of SAFETEA-LU, LDOTD must offer the concrete from the removal of the existing bridge to Federal, State, or local government entities.

**SEC. 1805. USE OF DEBRIS FROM DEMOLISHED BRIDGES AND OVERPASSES.**

(a) **IN GENERAL.**—Any State that demolishes a bridge or an overpass that is eligible for Federal assistance under the highway bridge replacement and rehabilitation program under section 144 of title 23, United States Code, is directed to first make the debris from the demolition of such bridge or overpass available for beneficial use by a Federal, State, or local government, unless such use obstructs navigation.

(b) **RECIPIENT RESPONSIBILITIES.**—A recipient of the debris described in subsection (a) shall—

- (1) bear the additional cost associated with having the debris made available;

H. R. 3—317

- (2) ensure that placement of the debris complies with applicable law; and

- (3) assume all future legal responsibility arising from the placement of the debris, which may include entering into an agreement to hold the owner of the demolished bridge or overpass harmless in any liability action.


(c) **DEFINITION.**—In this section, the term "beneficial use" means the application of the debris for purposes of shore erosion control or stabilization, ecosystem restoration, and marine habitat creation.


- c. Non-vegetated water bottoms (12,800 yd<sup>3</sup>) displaced by pile setting will be redistributed by natural wave action.
  - d. Concrete fill associated with construction of new bridge 11,192 yd<sup>3</sup>
  - e. Crushed stone fill and concrete fill associated with approaches to new bridge 2,212 yd<sup>3</sup>
  - f. Concrete fill associated with the removal of the old bridge 7,500 yd<sup>3</sup>
3. Properties adjacent to the proposed project area and the respective landowner information are attached to the application.
4. No falsework, temporary structures, or fender system will be utilized.
5. Wisner State Wildlife Management Area is located approximately 2 miles west from the proposed project area, Grand Isle State Park is located approximately 6 miles northeast from the proposed project area, East Timbalier Island National Wildlife Refuge is located approximately 20 miles southwest from the proposed project area, Faleau (historical) is located approximately 22 miles northwest from the proposed project area, Filapino (historical) is located approximately 26 miles northeast from the proposed project area, Swartze School (historical) is located approximately 30 miles northeast from the proposed project area, Sacred Heart Church (historical) is located approximately 31 miles north from the proposed project area, Bohemia State Wildlife Management Area is located approximately 32 miles northeast from the proposed project area, Burrwood (historical) is located approximately 42 miles southeast from the proposed project area, Delta National Wildlife Refuge is located approximately 46 miles southeast from the proposed project area, and Pass a Loutre State Water Fowl Management Area is located approximately 47 miles southeast from the proposed project area.

**General Notes  
Caminada Bay Bridge**

**Coastal Use Permit  
SPN 064-01-0040/FAP BR-52-01(001)  
Jefferson Parish, Louisiana**

**Louisiana  
Department of Transportation and Development**

 <b>PROVIDENCE</b>	Drawn By	LMM	12/19/08
	Checked By	DRA	12/19/08
	Approved By		
	Project Number	040-007	<b>3</b> Figure
	Drawing Number	040-007-A534	

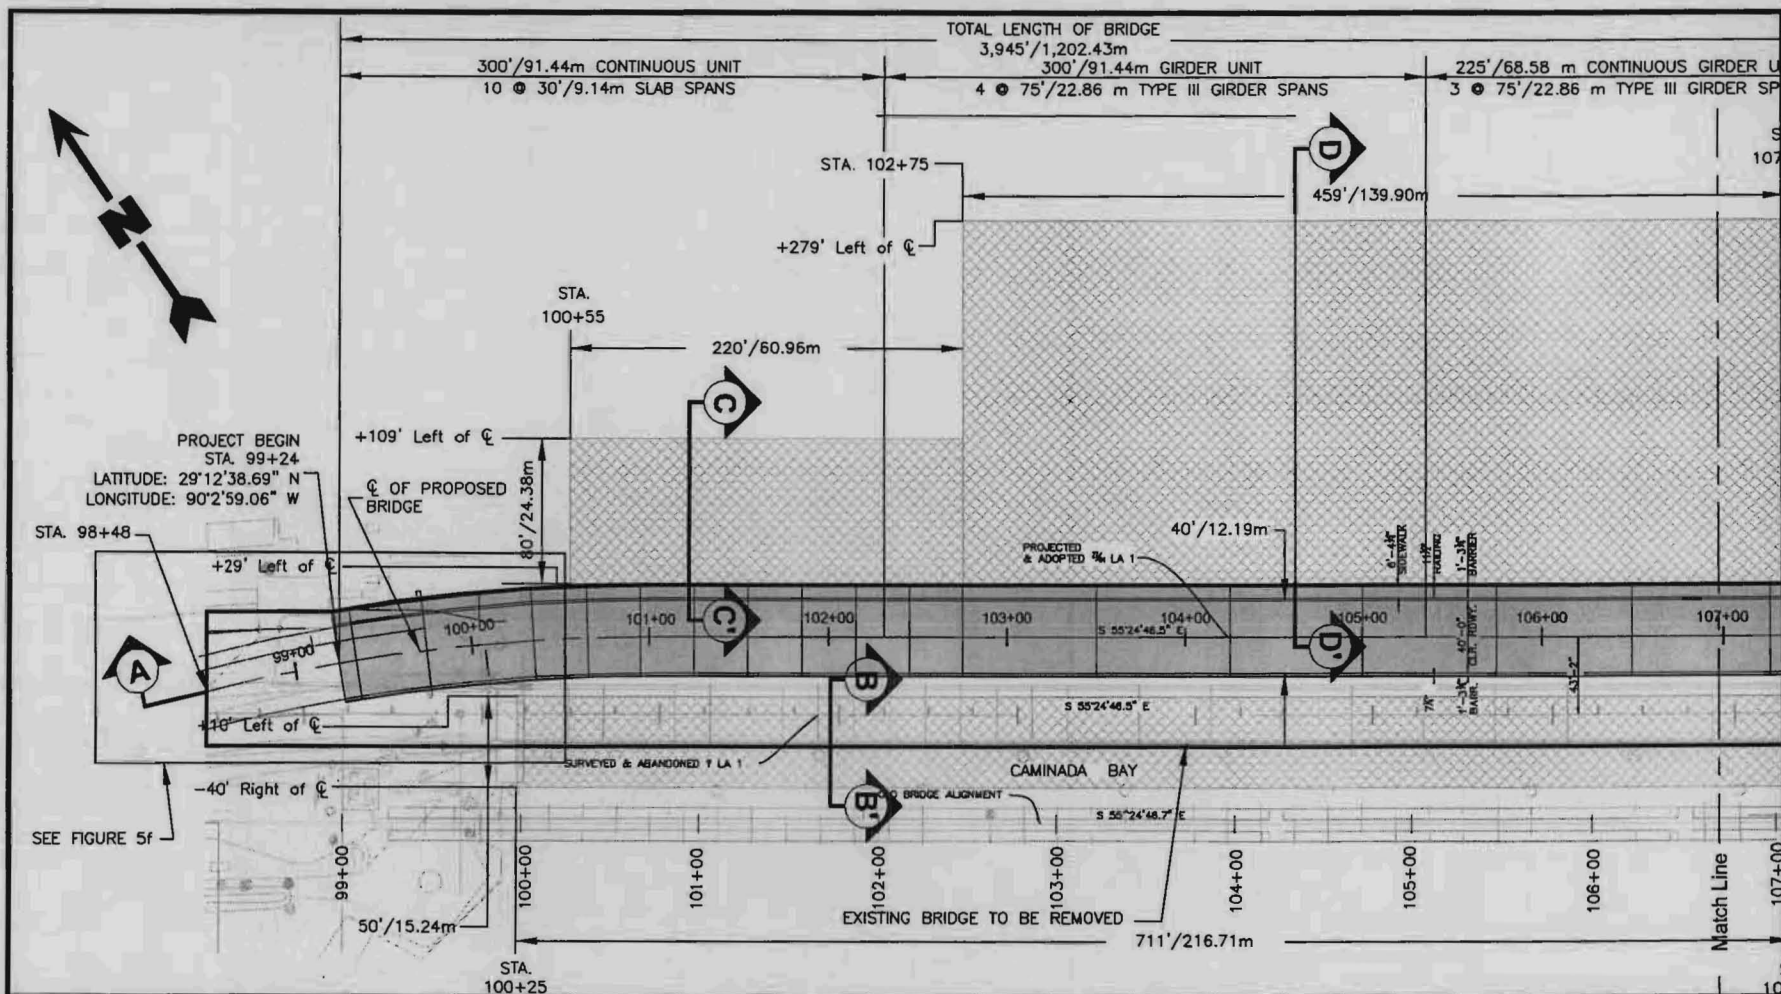


### Legend

- Project Area (8.62 Acres)
- Proposed Bridge
- Proposed Approach
- Proposed Area To Be Dredged (9.20 Acres)

### Notes

1. Fill associated with the proposed project will consist of the displacement of 12,800 yd<sup>3</sup> of non-vegetated water bottoms associated with the setting of bridge piles.
2. All fill associated with dredged water bottoms will be hauled offsite.
3. All construction will occur within the project area (work area).
4. Concrete associated with construction of new bridge 11,192 yd<sup>3</sup>.
5. Concrete associated with approaches to new bridge 222 yd<sup>3</sup>.
6. Crushed stone fill associated with approaches to new bridge 1,989 yd<sup>3</sup>.

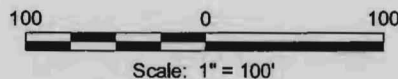

### Reference

Base drawing provided by client.

## Site Plan Caminada Bay Bridge

Coastal Use Permit  
SPN 064-01-0040/FAP BR-52-01(001)  
Jefferson Parish, Louisiana


Louisiana  
Department of Transportation and Development



Drawn By	LMM	09/29/08
Checked By	DRA	09/29/08
Approved By		
Project Number	040-007	
Drawing Number	040-007-A329	


**4a**  
Figure



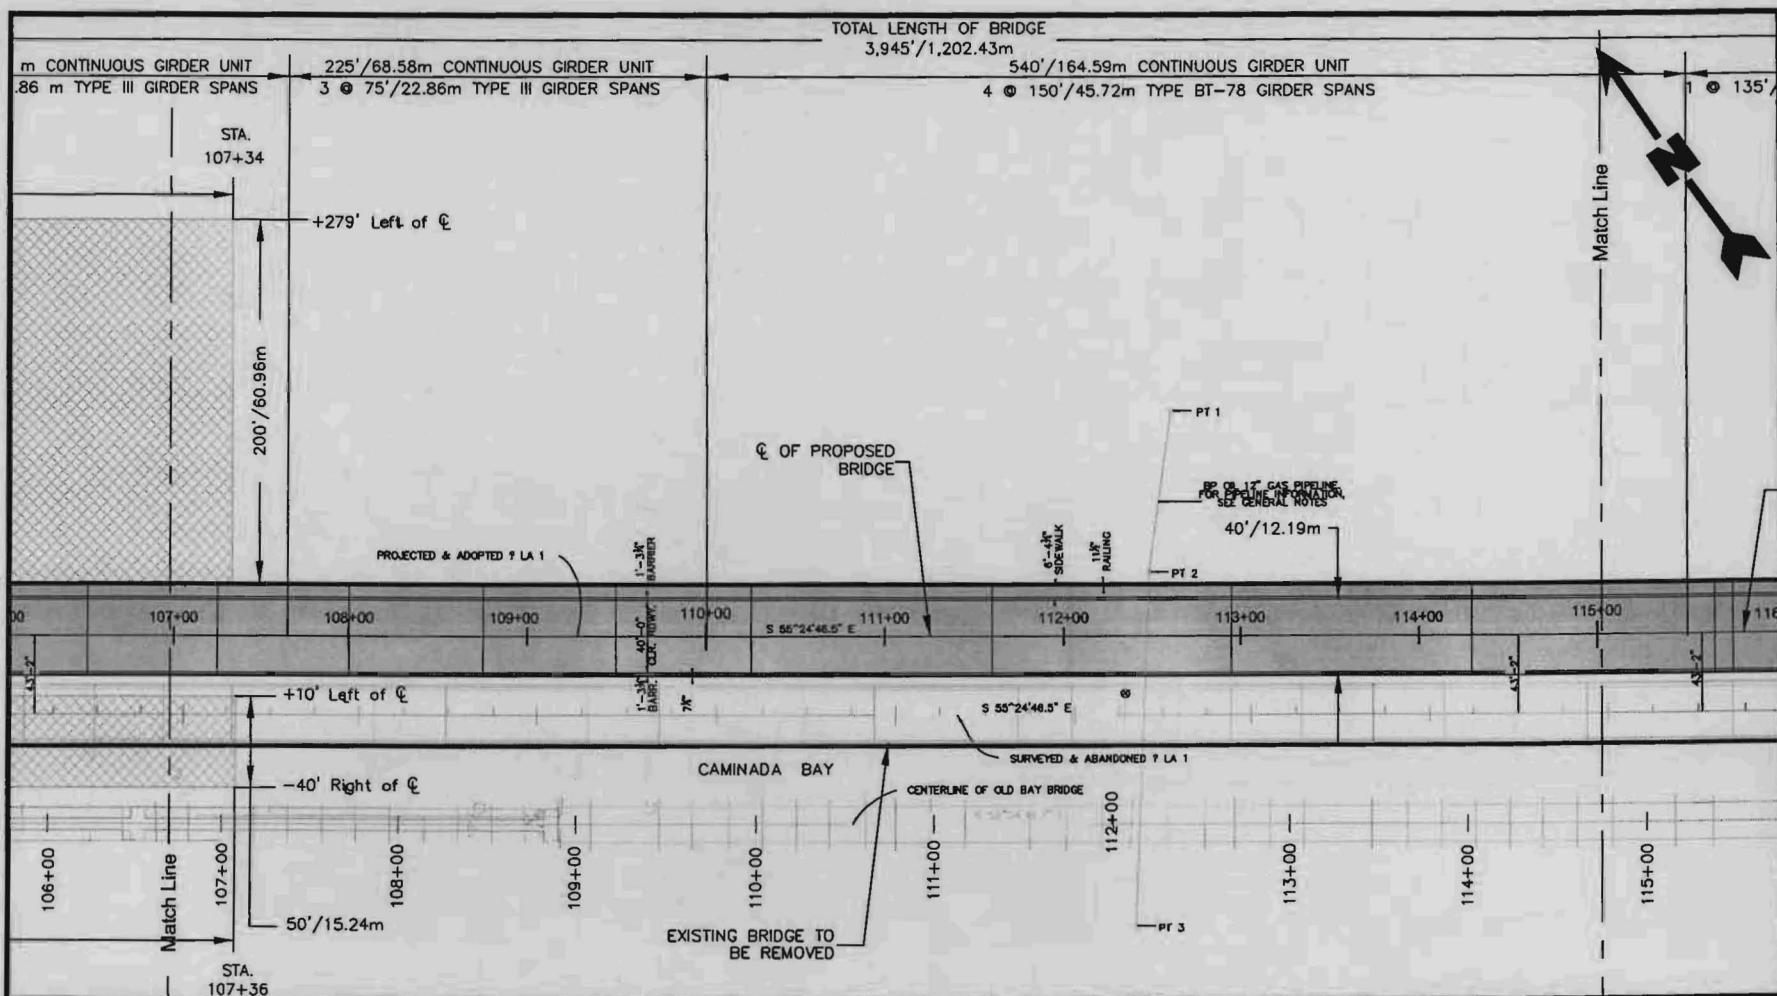

## Legend

- Project Area (8.62 Acres)
- Proposed Bridge
- Proposed Area To Be Dredged (9.20 Acres)

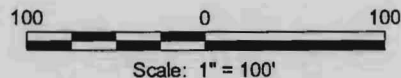

## Notes

- Fill associated with the proposed project will consist of the displacement of 12,800 yd<sup>3</sup> of non-vegetated water bottoms associated with the setting of bridge piles.
- All fill associated with dredged water bottoms will be hauled offsite.
- All construction will occur within the project area (work area).
- Concrete associated with construction of new bridge 11,192 yd<sup>3</sup>.
- Concrete associated with approaches to new bridge 222 yd<sup>3</sup>.
- Crushed stone fill associated with approaches to new bridge 1,990 yd<sup>3</sup>.

## Reference

Base drawing provided by client.

## Site Plan Caminada Bay Bridge

Coastal Use Permit  
SPN 064-01-0040/FAP BR-52-01(001)  
Jefferson Parish, Louisiana


### Louisiana Department of Transportation and Development



Drawn By	LMM	09/29/08
Checked By	DRA	09/29/08
Approved By		
Project Number		040-007
Drawing Number		040-007-A330


4b

Figure

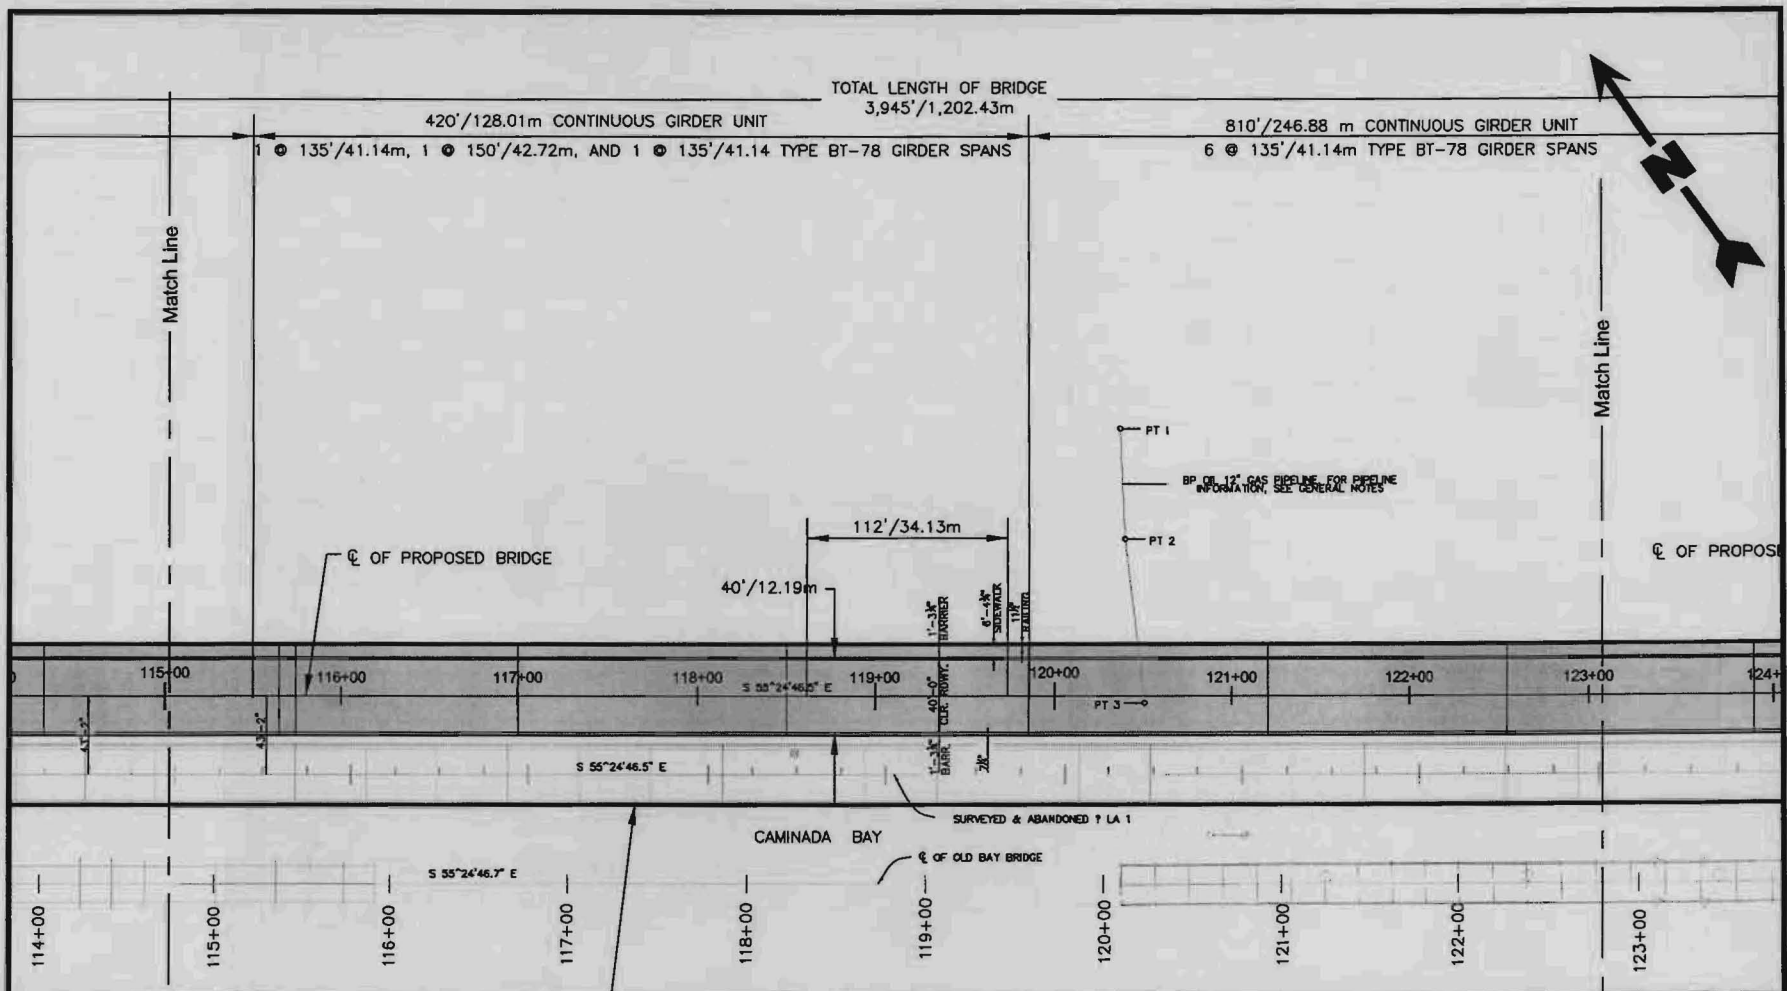

## Legend

- Project Area (8.62 Acres)
- Proposed Bridge

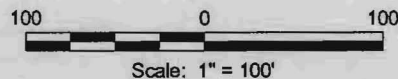

## Notes

1. Fill associated with the proposed project will consist of the displacement of 12,800 yd<sup>3</sup> of non-vegetated water bottoms associated with the setting of bridge piles.
2. All fill associated with dredged water bottoms will be hauled offsite.
3. All construction will occur within the project area (work area).
4. Concrete associated with construction of new bridge 11,192 yd<sup>3</sup>.
5. Concrete associated with approaches to new bridge 222 yd<sup>3</sup>.
6. Crushed stone fill associated with approaches to new bridge 1,989 yd<sup>3</sup>.

## Reference

Base drawing provided by client.


**Site Plan**  
**Caminada Bay Bridge**  
 Coastal Use Permit  
 SPN 064-01-0040/FAP BR-52-01(001)  
 Jefferson Parish, Louisiana

**Louisiana**  
**Department of Transportation and Development**




Drawn By	LMM	09/29/08
Checked By	DRA	09/29/08
Approved By		
Project Number	040-007	
Drawing Number	040-007-A331	

**4c**  
 Figure

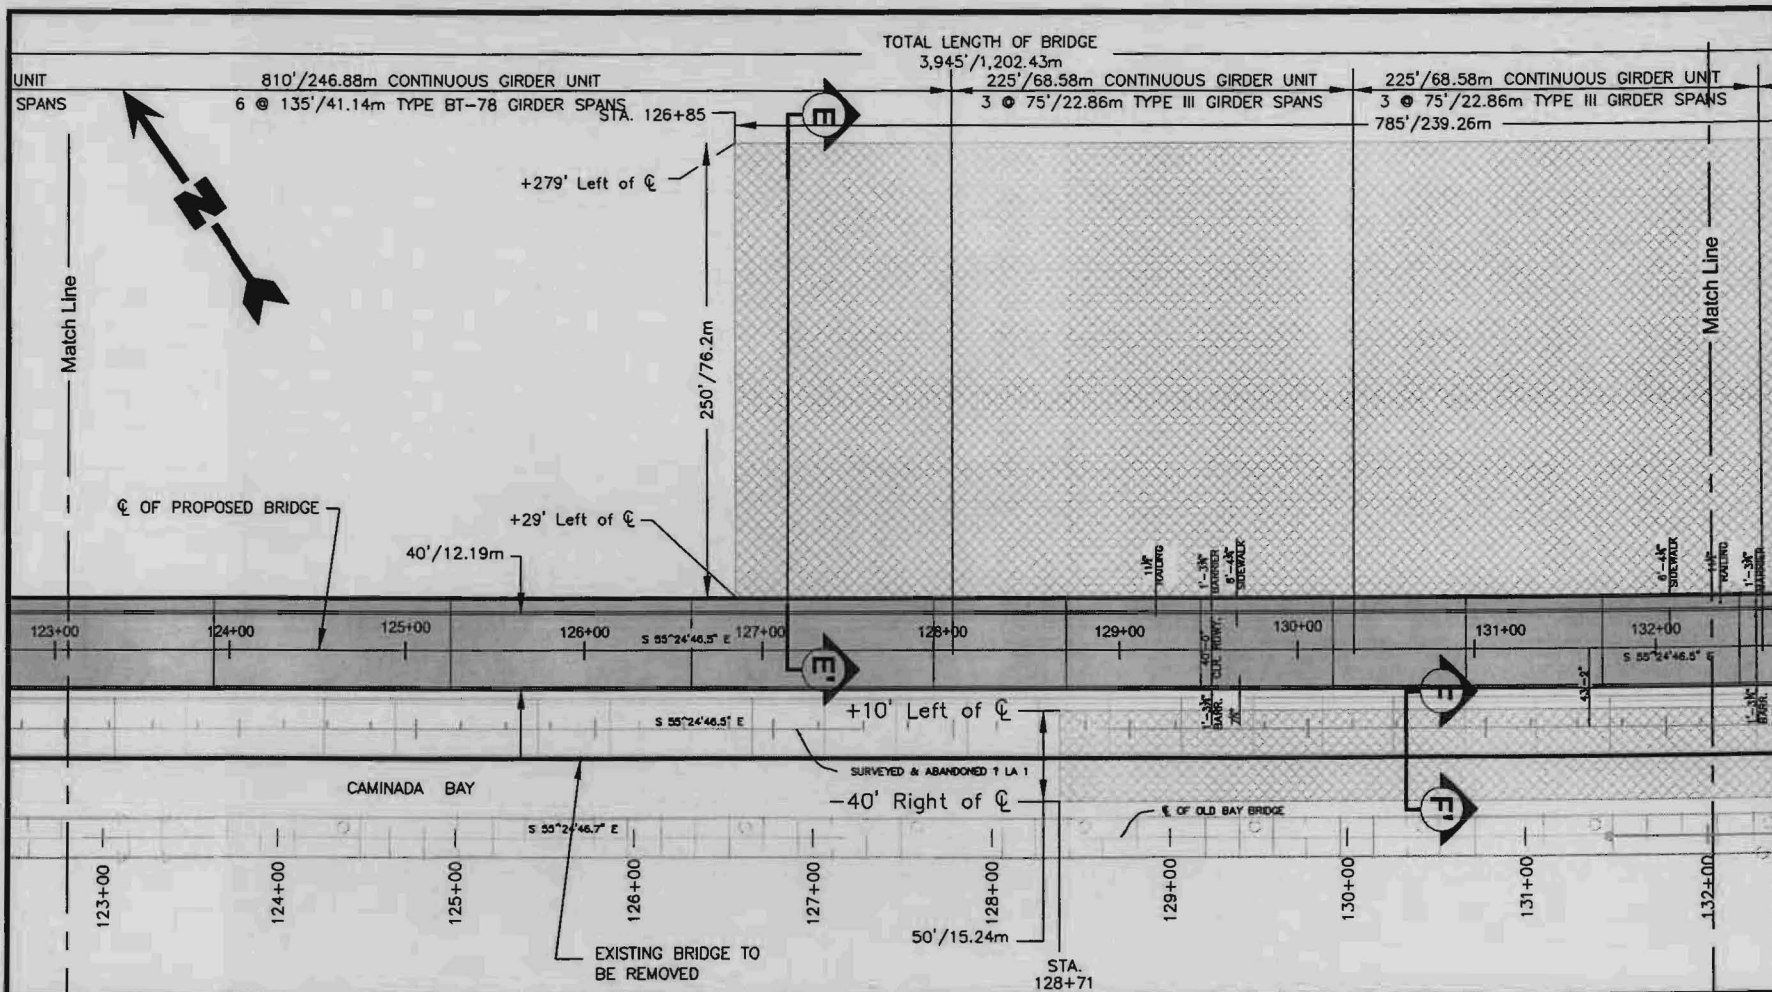

### Legend

- Project Area (8.62 Acres)
- Proposed Bridge
- Proposed Area To Be Dredged (9.20 Acres)

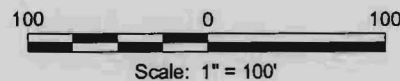

### Notes

1. Fill associated with the proposed project will consist of the displacement of 12,800 yd<sup>3</sup> of non-vegetated water bottoms associated with the setting of bridge piles.
2. All fill associated with dredged water bottoms will be hauled offsite.
3. All construction will occur within the project area (work area).
4. Concrete associated with construction of new bridge 11,192 yd<sup>3</sup>.
5. Concrete associated with approaches to new bridge 222 yd<sup>3</sup>.
6. Crushed stone fill associated with approaches to new bridge 1,989 yd<sup>3</sup>.

### Reference

Base drawing provided by client.

**Site Plan**  
**Camanada Bay Bridge**  
 Coastal Use Permit  
 SPN 064-01-0040/FAP BR-52-01(001)  
 Jefferson Parish, Louisiana


**Louisiana**  
**Department of Transportation and Development**



**PROVIDENCE**

Drawn By	LMM	09/29/08
Checked By	DRA	09/29/08
Approved By		
Project Number	040-007	
Drawing Number	040-007-A332	

**4d**  
Figure

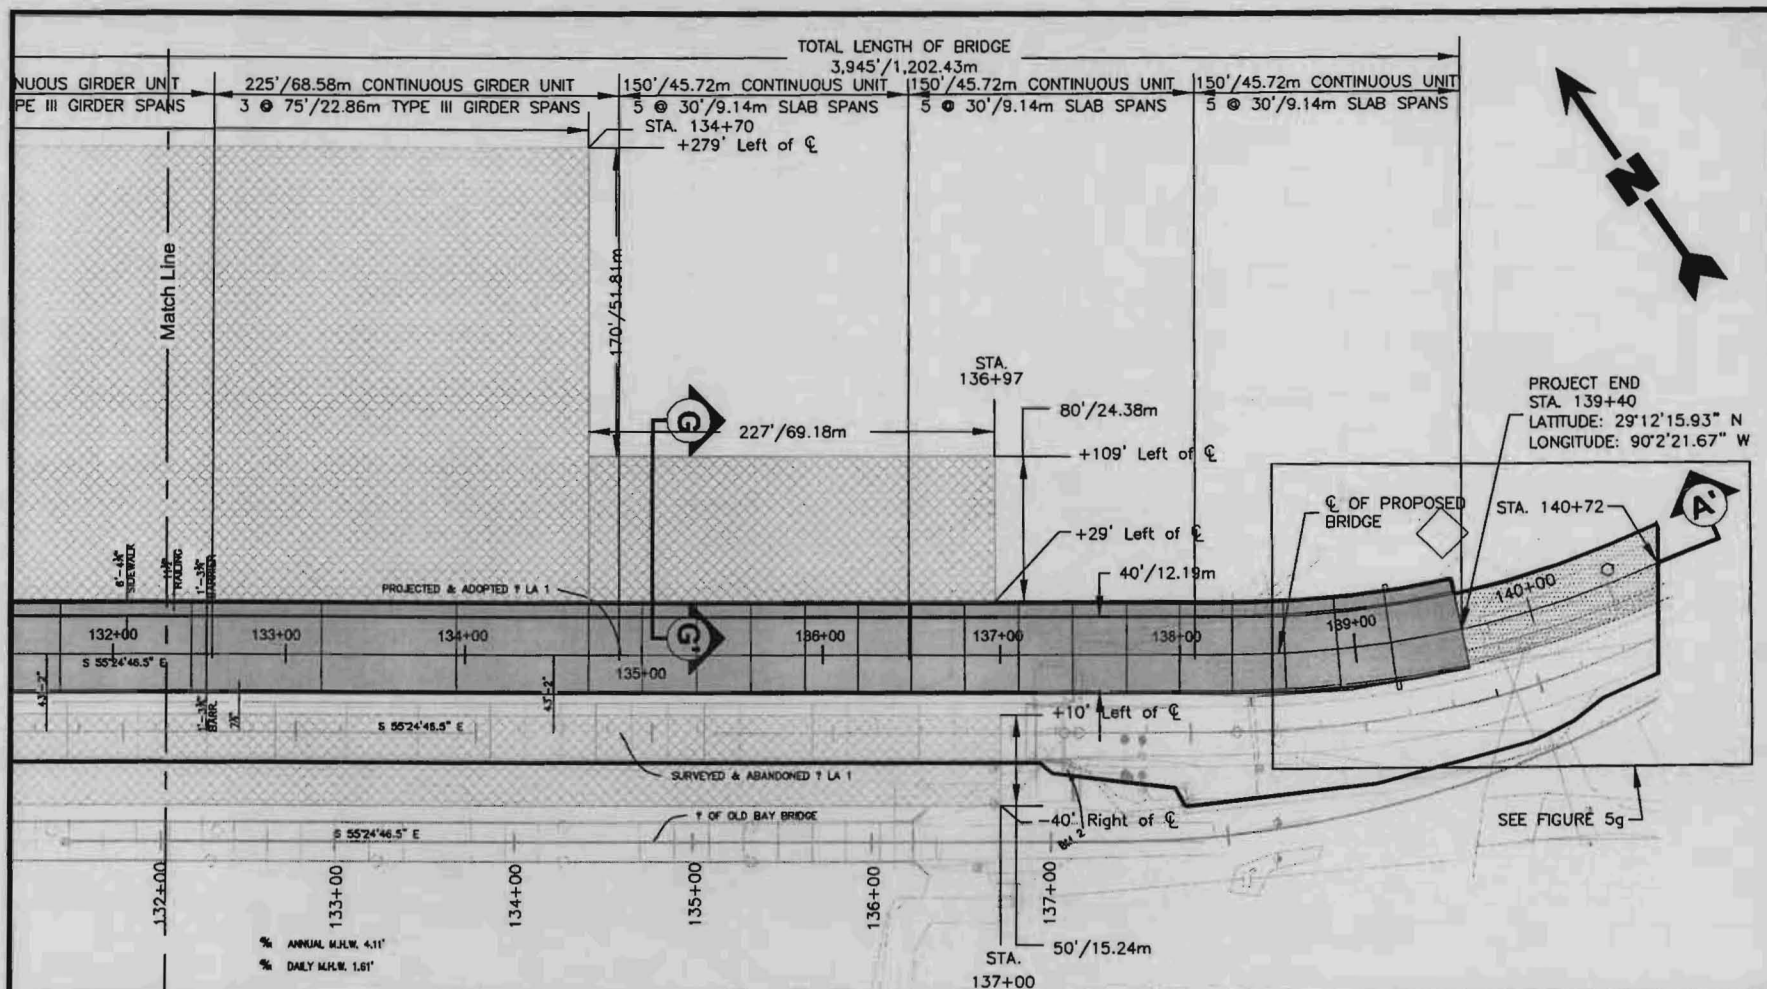


## Legend

- Project Area (8.62 Acres)
- Proposed Bridge
- Proposed Approach
- Proposed Area To Be Dredged (9.20 Acres)

## Notes

1. Fill associated with the proposed project will consist of the displacement of 12,800 yd<sup>3</sup> of non-vegetated water bottoms associated with the setting of bridge piles.
2. All fill associated with dredged water bottoms will be hauled offsite.
3. All construction will occur within the project area (work area).
4. Concrete associated with construction of new bridge 11,192 yd<sup>3</sup>.
5. Concrete associated with approaches to new bridge 222 yd<sup>3</sup>.
6. Crushed stone fill associated with approaches to new bridge 1,989 yd<sup>3</sup>.

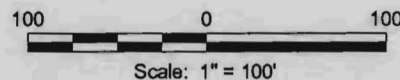

## Reference

Base drawing provided by client.

## Site Plan Caminada Bay Bridge

Coastal Use Permit  
SPN 064-01-0040/FAP BR-52-01(001)  
Jefferson Parish, Louisiana


Louisiana  
Department of Transportation and Development



Drawn By	LMM	09/29/08
Checked By	DRA	09/29/08
Approved By		
Project Number	040-007	
Drawing Number	040-007-A333	

**4e**  
Figure



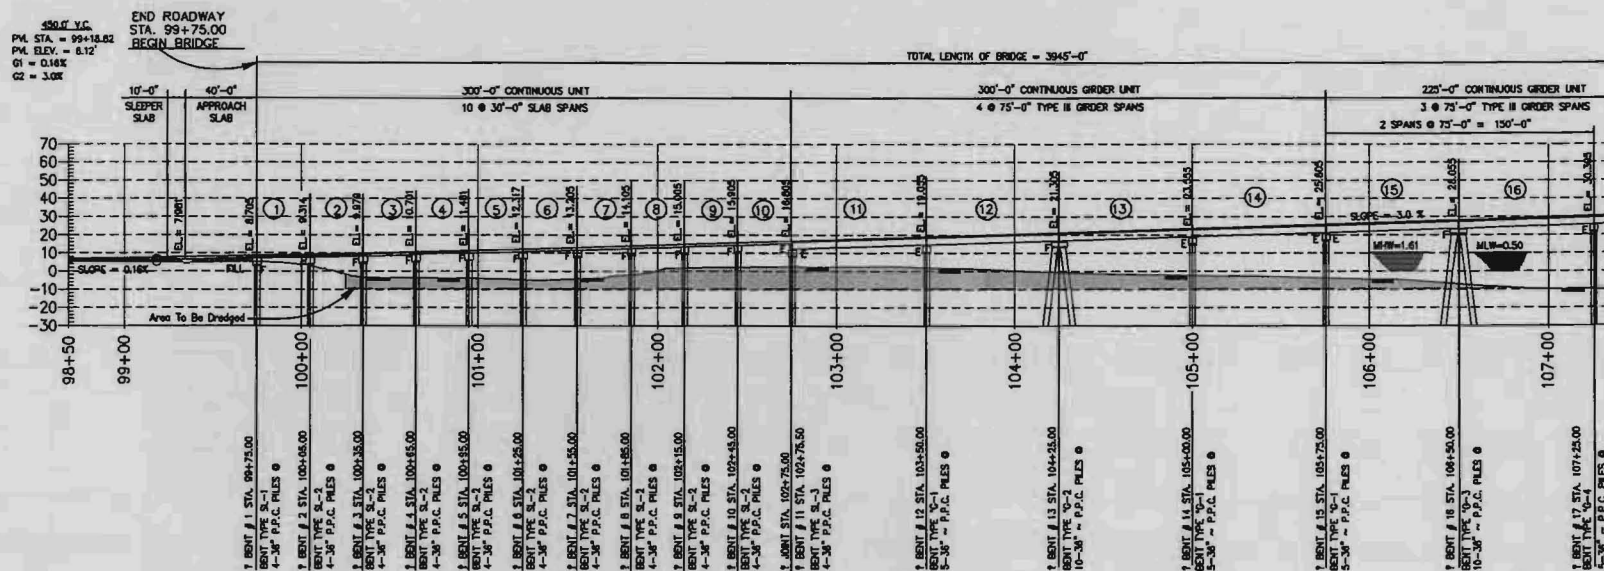

**Profile A-A'**

Scale: 1" = 100'

## Legend



Proposed Area To Be Dredged

Construction of New Bridge = 59,100 yds<sup>3</sup>


Removal of Old Bridge = 15,700 yds<sup>3</sup>

Maintenance Dredging = 7,500 yds<sup>3</sup>

TOTAL = 82,300 yds<sup>3</sup>

## Notes

1. Fill associated with the proposed project will consist of the displacement of 12,800 yd<sup>3</sup> of non-vegetated water bottoms associated with the setting of bridge piles.
2. All fill associated with dredged water bottoms will be hauled offsite.
3. Concrete associated with construction of new bridge 11,192 yd<sup>3</sup>.
4. Crushed stone fill associated with approaches to new bridge 1,989 yd<sup>3</sup>.

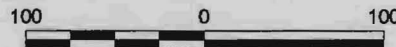

Scale: 1" = 100'

## Reference

Base drawing provided by client.

**Profile View A-A'**  
**Caminada Bay Bridge**  
Coastal Use Permit  
SPN 064-01-0040/FAP BR-52-01(001)  
Jefferson Parish, Louisiana

Louisiana  
Department of Transportation and Development



**PROVIDENCE**

Drawn By LMM 09/29/08

Checked By DRA 09/29/08


Approved By

Project Number  
040-007

Drawing Number  
040-007-A334

**5a**


Figure

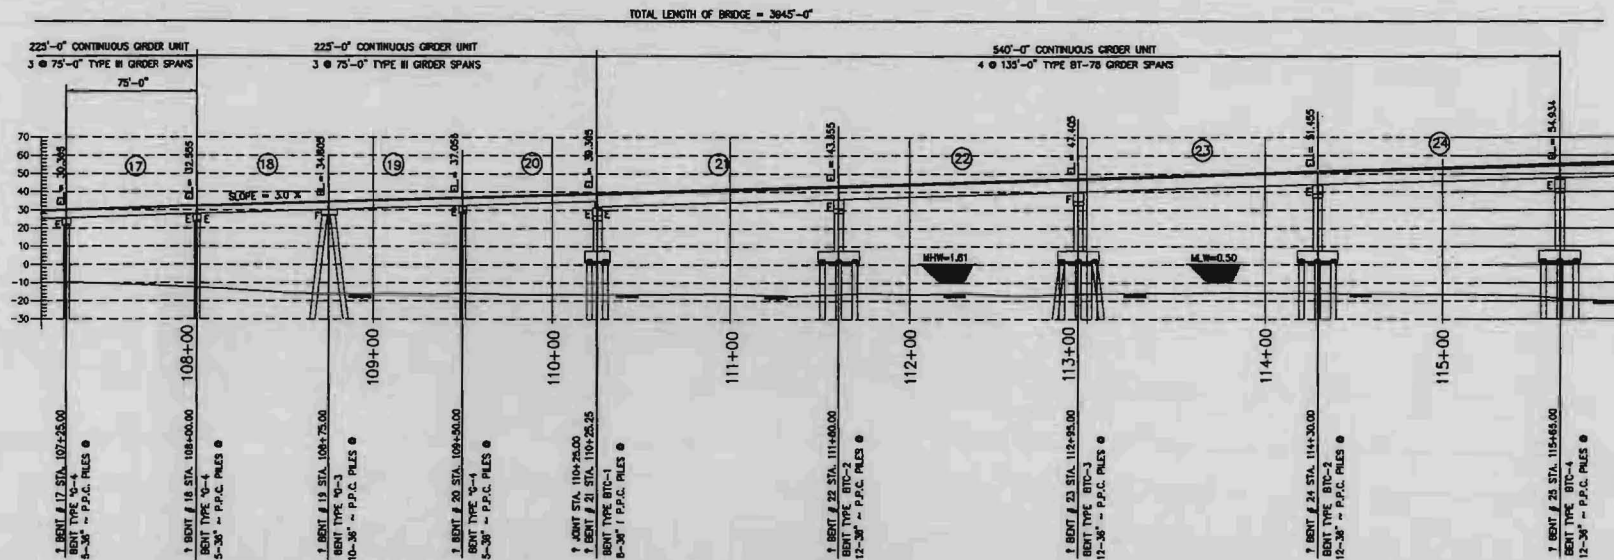

**Profile A-A'**

Scale: 1" = 100'

## Legend

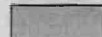

Proposed Area To Be Dredged

Construction of New Bridge = 59,100 yds<sup>3</sup>


Removal of Old Bridge = 15,700 yds<sup>3</sup>

Maintenance Dredging = 7,500 yds<sup>3</sup>

TOTAL = 82,300 yds<sup>3</sup>

## Notes

1. Fill associated with the proposed project will consist of the displacement of 12,800 yd<sup>3</sup> of non-vegetated water bottoms associated with the setting of bridge piles.
2. All fill associated with dredged water bottoms will be hauled offsite.
3. Concrete associated with construction of new bridge 11,192 yd<sup>3</sup>.
4. Crushed stone fill associated with approaches to new bridge 1,989 yd<sup>3</sup>.

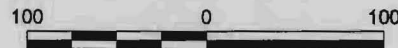

Scale: 1" = 100'

## Reference

Base drawing provided by client.

## Profile View A-A' Caminada Bay Bridge

Coastal Use Permit

SPN 064-01-0040/FAP BR-52-01(001)

Jefferson Parish, Louisiana

Louisiana  
Department of Transportation and Development




**PROVIDENCE**

Drawn By	LMM	09/29/08
Checked By	DRA	09/29/08
Approved By		

Project Number	040-007
Drawing Number	040-007-A335

**5b**

Figure

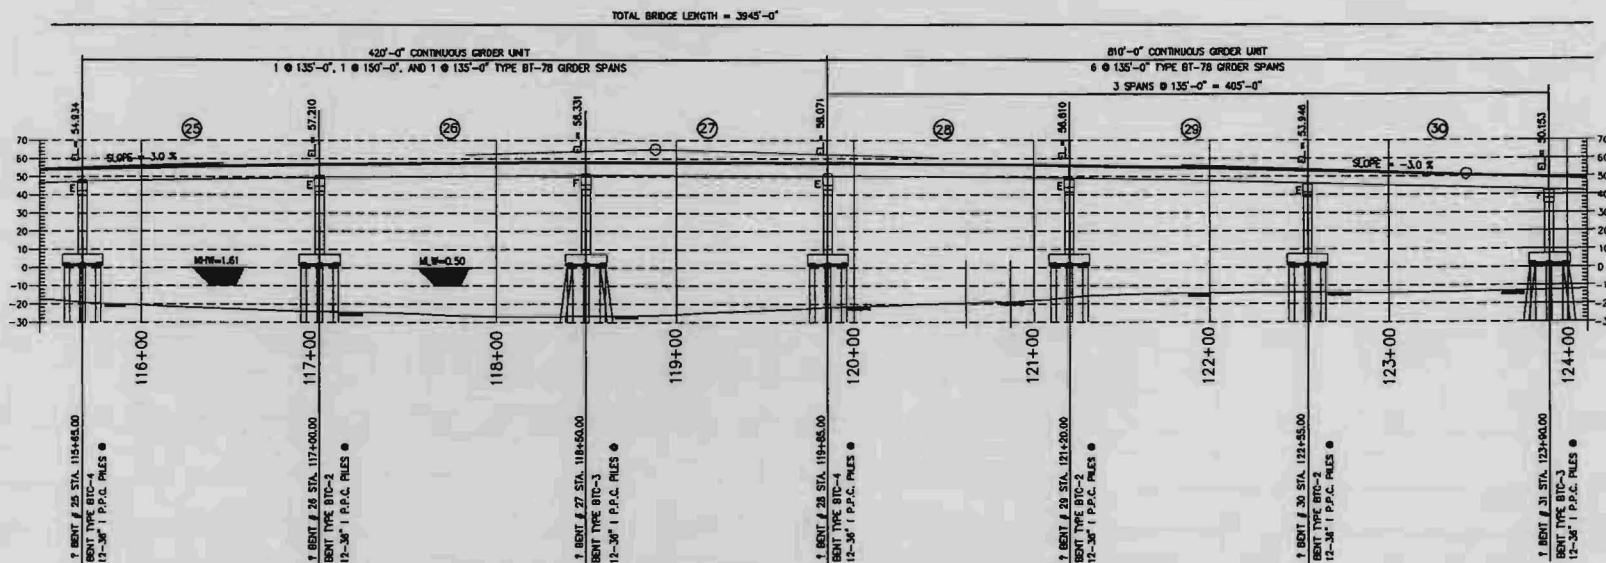


## Legend



Proposed Area To Be Dredged  
Construction of New Bridge = 59,100 yds<sup>3</sup>  
Removal of Old Bridge = 15,700 yds<sup>3</sup>  
Maintenance Dredging = 7,500 yds<sup>3</sup>  
TOTAL = 82,300 yds<sup>3</sup>

## Notes

1. Fill associated with the proposed project will consist of the displacement of 12,800 yd<sup>3</sup> of non-vegetated water bottoms associated with the setting of bridge piles.
2. All fill associated with dredged water bottoms will be hauled offsite.
3. Concrete associated with construction of new bridge 11,192 yd<sup>3</sup>.
4. Crushed stone fill associated with approaches to new bridge 1,989 yd<sup>3</sup>.

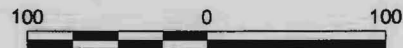

Scale: 1" = 100'

## Reference

Base drawing provided by client.

**Profile View A-A'**  
**Caminada Bay Bridge**  
Coastal Use Permit  
SPN 064-01-0040/FAP BR-52-01(001)  
Jefferson Parish, Louisiana

Louisiana  
Department of Transportation and Development




**PROVIDENCE**

Drawn By	LMM	09/29/08
Checked By	DRA	09/29/08
Approved By		

Project Number  
040-007

Drawing Number  
040-007-A336

**5c**  
Figure

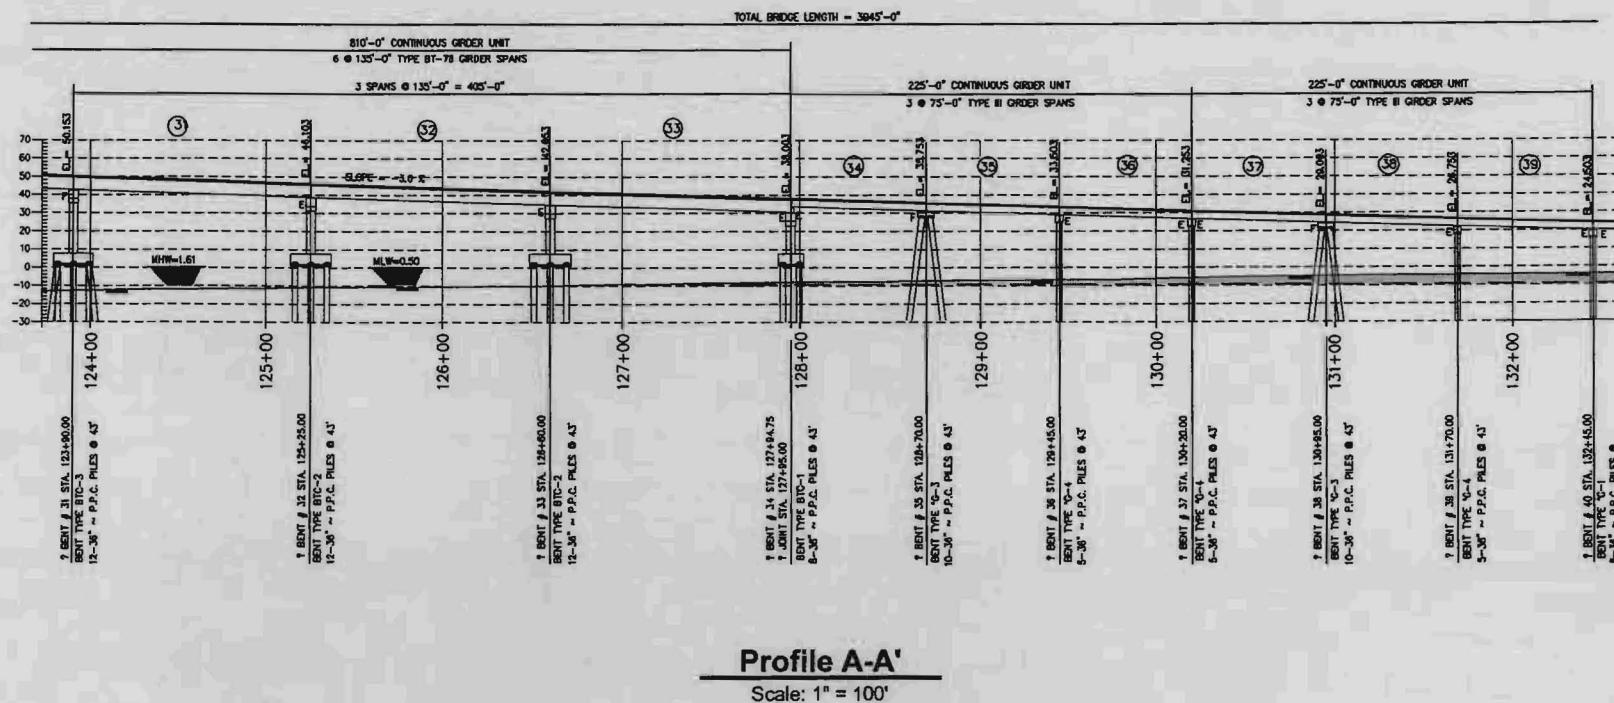

## Legend



Proposed Area To Be Dredged

Construction of New Bridge = 59,100 yds<sup>3</sup>


Removal of Old Bridge = 15,700 yds<sup>3</sup>

Maintenance Dredging = 7,500 yds<sup>3</sup>

TOTAL = 82,300 yds<sup>3</sup>

## Notes

1. Fill associated with the proposed project will consist of the displacement of 12,800 yd<sup>3</sup> of non-vegetated water bottoms associated with the setting of bridge piles.
2. All fill associated with dredged water bottoms will be hauled offsite.
3. Concrete associated with construction of new bridge 11,192 yd<sup>3</sup>.
4. Crushed stone fill associated with approaches to new bridge 1,989 yd<sup>3</sup>.

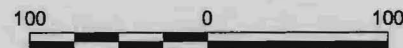

Scale: 1" = 100'

## Reference

Base drawing provided by client.


**Profile View A-A'**  
**Caminada Bay Bridge**  
Coastal Use Permit  
SPN 064-01-0040/FAP BR-52-01(001)  
Jefferson Parish, Louisiana

Louisiana  
Department of Transportation and Development



Drawn By	LMM	09/29/08
Checked By	DRA	09/29/08
Approved By		
Project Number	040-007	<b>5d</b> Figure
Drawing Number	040-007-A337	



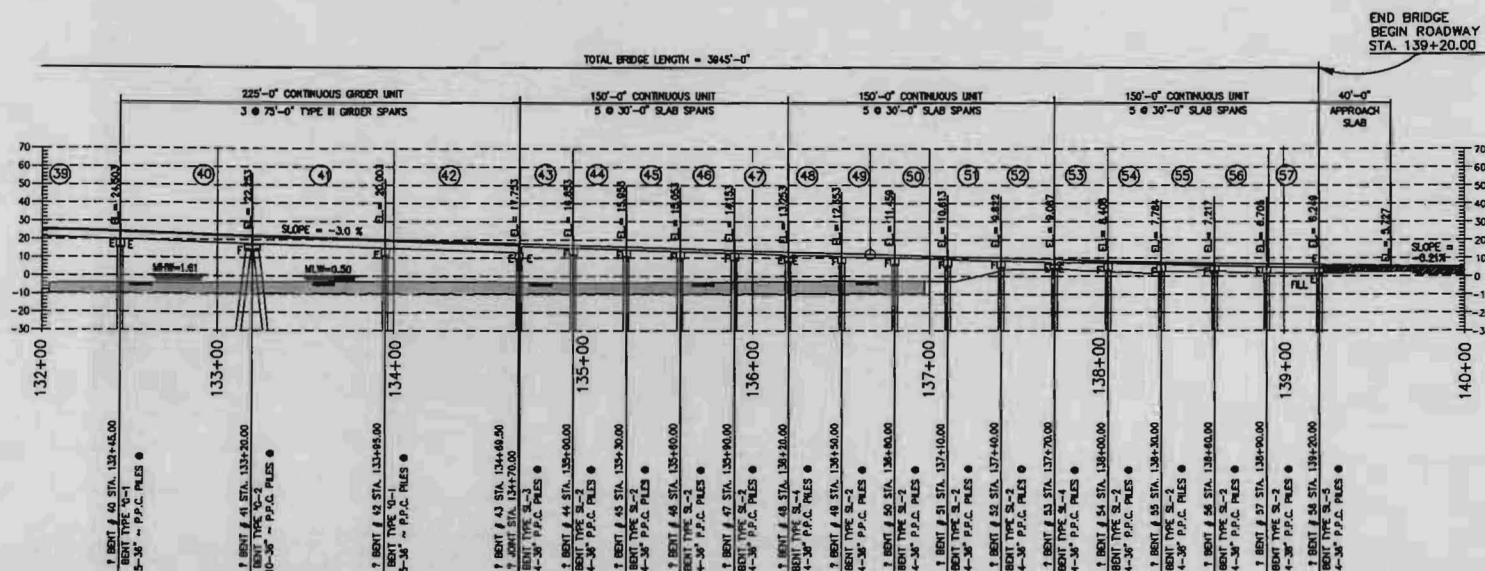

**Profile A-A'**

Scale: 1" = 100'

## Legend



Proposed Area To Be Dredged

Construction of New Bridge = 59,100 yds<sup>3</sup>


Removal of Old Bridge = 15,700 yds<sup>3</sup>

Maintenance Dredging = 7,500 yds<sup>3</sup>

TOTAL = 82,300 yds<sup>3</sup>

## Notes

1. Fill associated with the proposed project will consist of the displacement of 12,800 yd<sup>3</sup> of non-vegetated water bottoms associated with the setting of bridge piles.
2. All fill associated with dredged water bottoms will be hauled offsite.
3. Concrete associated with construction of new bridge 11,192 yd<sup>3</sup>.
4. Crushed stone fill associated with approaches to new bridge 1,989 yd<sup>3</sup>.

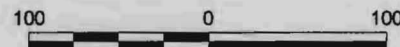

Scale: 1" = 100'

## Reference

Base drawing provided by client.

**Profile View A-A'**  
**Caminada Bay Bridge**  
Coastal Use Permit  
SPN 064-01-0040/FAP BR-52-01(001)  
Jefferson Parish, Louisiana

Louisiana  
Department of Transportation and Development




**PROVIDENCE**

Drawn By	LMM	09/29/08
Checked By	DRA	09/29/08
Approved By		

Project Number	040-007
Drawing Number	040-007-A338

**5e**  
Figure

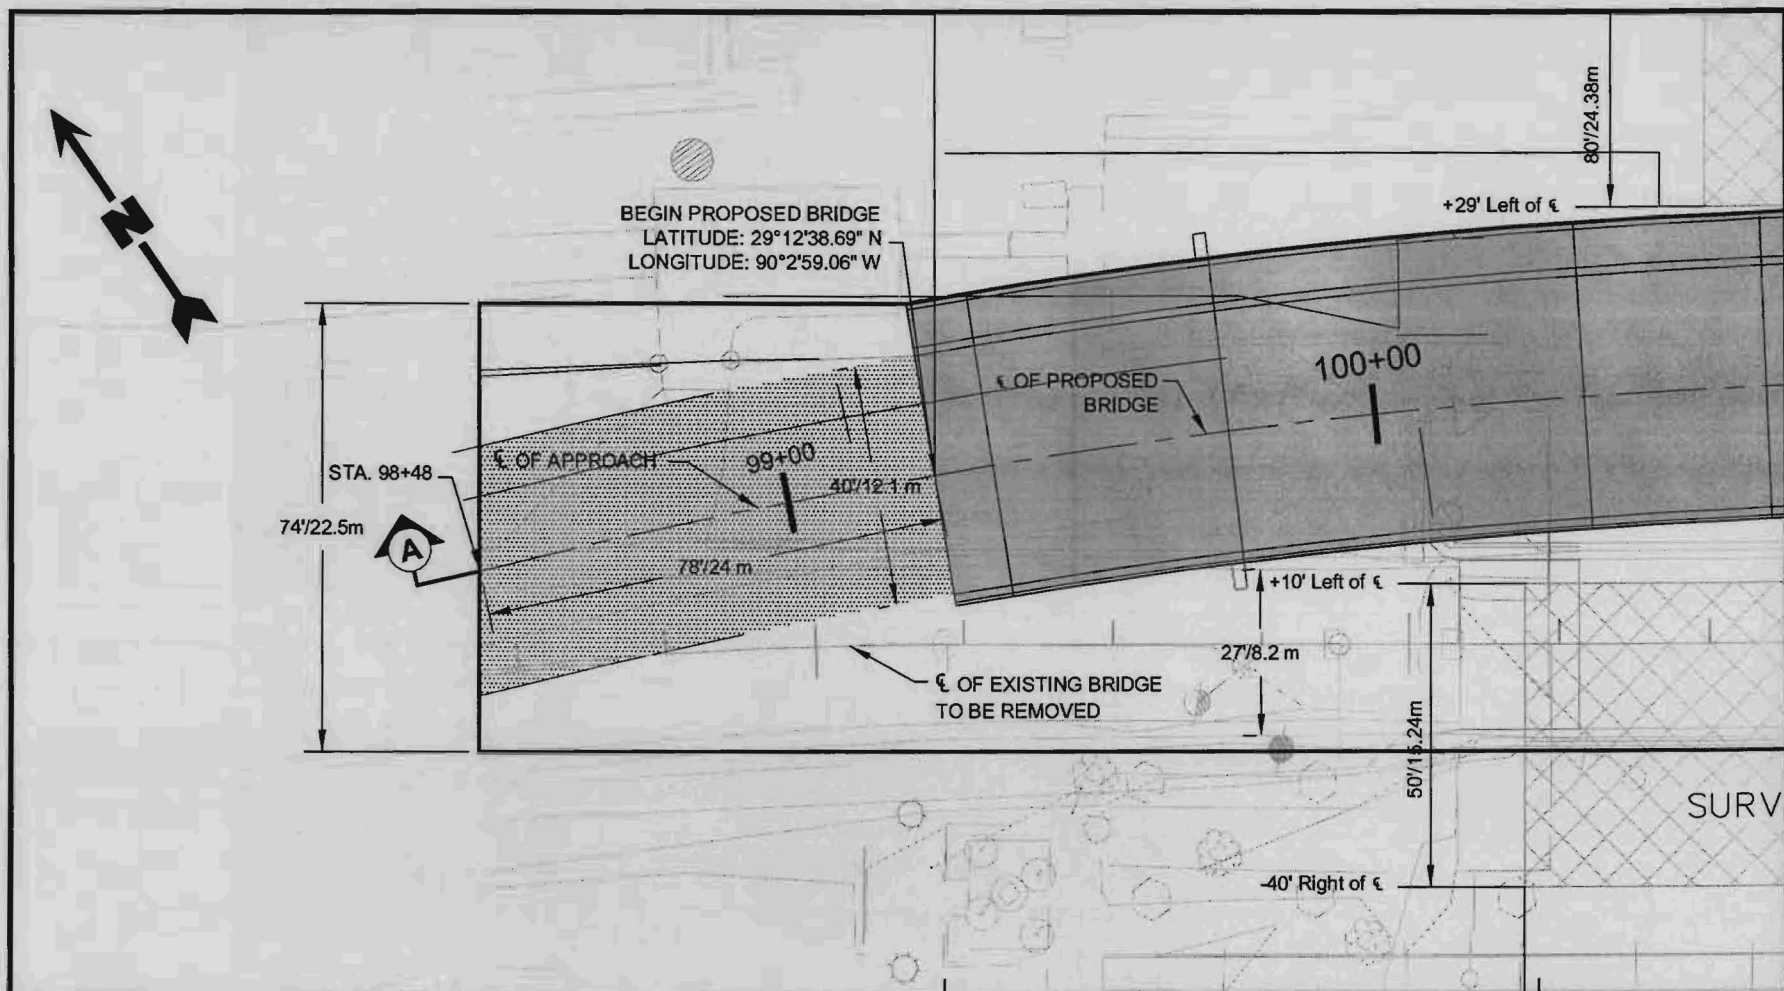


### Legend

- Project Area (8.62 Acres)
- Proposed Bridge
- Proposed Approach
- Proposed Area To Be Dredged (9.20 Acres)

### Notes

1. Fill associated with the proposed project will consist of the displacement of 12,800 yd<sup>3</sup> of non-vegetated water bottoms associated with the setting of bridge piles.
2. All fill associated with dredged water bottoms will be hauled offsite.
3. All construction will occur within the project area (work area).
4. Concrete associated with construction of new bridge 11,192 yd<sup>3</sup>.
5. Concrete associated with approaches to new bridge 222 yd<sup>3</sup>.
6. Crushed stone fill associated with approaches to new bridge 1,989 yd<sup>3</sup>.

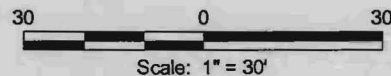

### Reference

Base drawing provided by client.

## North Approach Caminada Bay Bridge

Coastal Use Permit  
SPN 064-01-0040/FAP BR-52-01(001)  
Jefferson Parish, Louisiana

### Louisiana Department of Transportation and Development




**PROVIDENCE**

Drawn By	LMM	10/28/08
Checked By	DRA	10/28/08
Approved By		

Project Number  
040-007  
Drawing Number  
040-007-A473

**5f**  
Figure

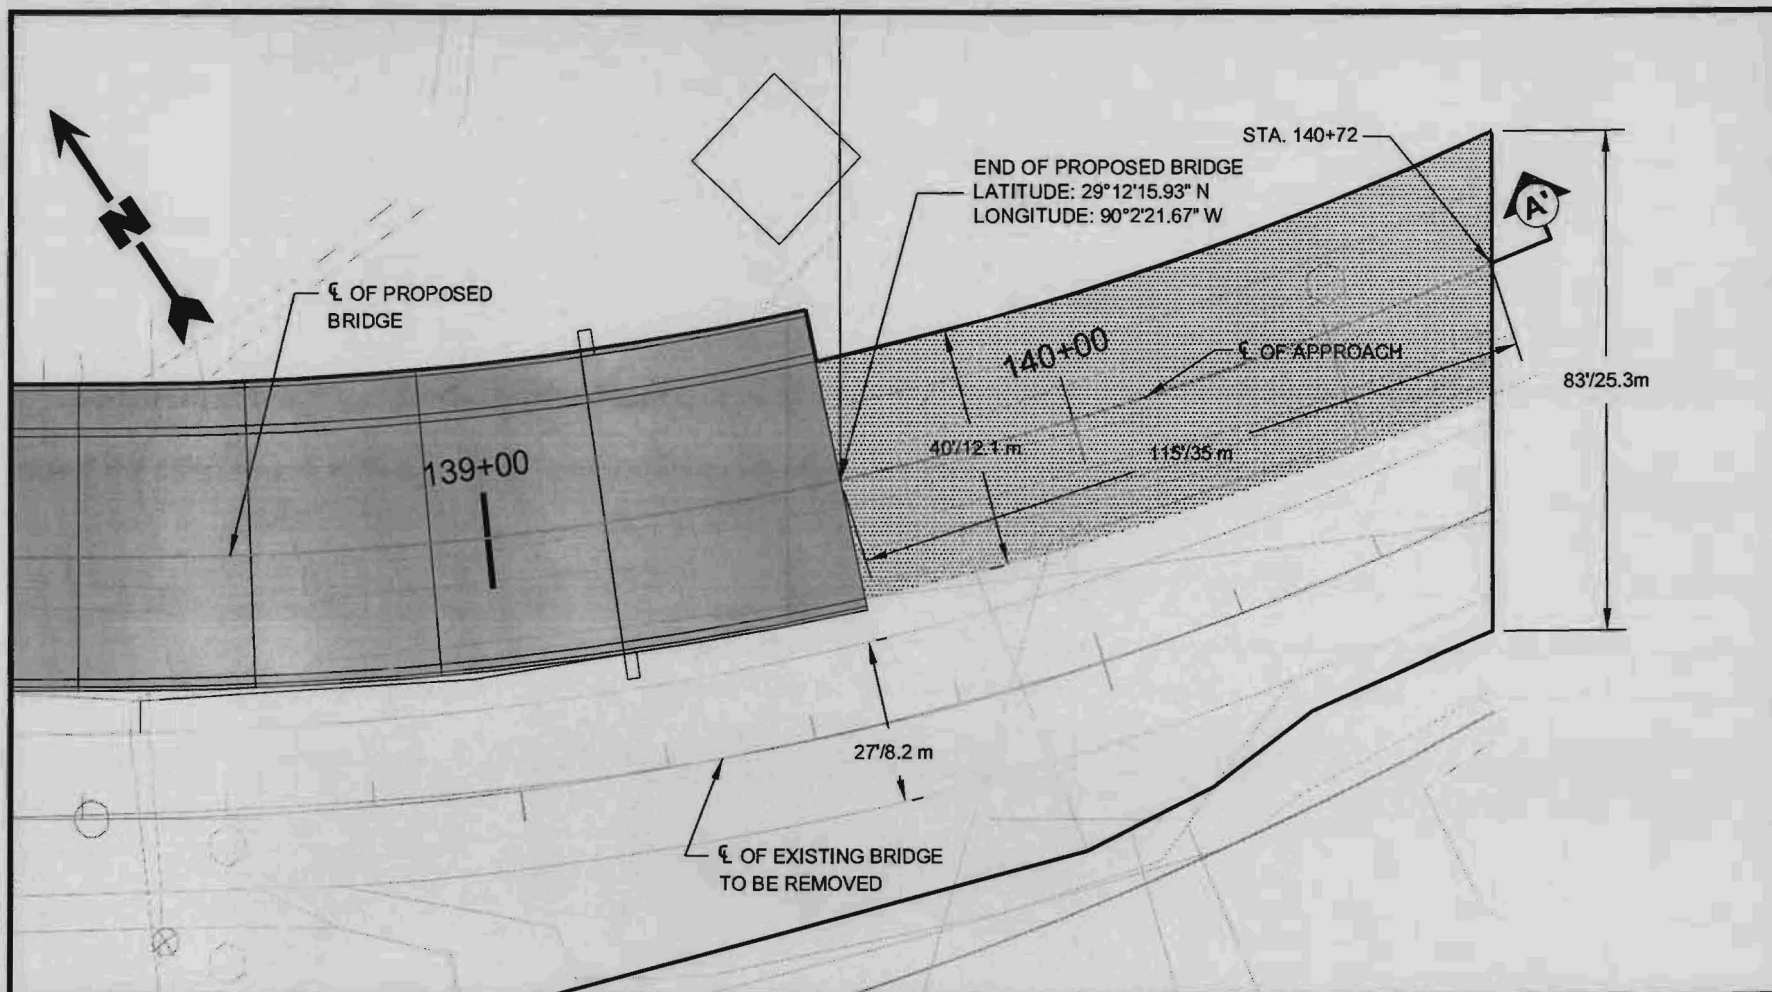


### Legend

- Project Area (8.62 Acres)
- Proposed Bridge
- Proposed Approach
- Proposed Area To Be Dredged (9.20 Acres)

### Notes

1. Fill associated with the proposed project will consist of the displacement of 12,800 yd<sup>3</sup> of non-vegetated water bottoms associated with the setting of bridge piles.
2. All fill associated with dredged water bottoms will be hauled offsite.
3. All construction will occur within the project area (work area).
4. Concrete associated with construction of new bridge 11,192 yd<sup>3</sup>.
5. Concrete associated with approaches to new bridge 222 yd<sup>3</sup>.
6. Crushed stone fill associated with approaches to new bridge 1,989 yd<sup>3</sup>.

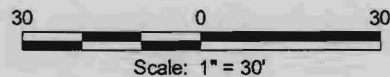

### Reference

Base drawing provided by client.

**South Approach  
Caminada Bay Bridge**  
Coastal Use Permit  
SPN 064-01-0040/FAP BR-52-01(001)  
Jefferson Parish, Louisiana

**Louisiana  
Department of Transportation and Development**




**PROVIDENCE**

Drawn By	LMM	10/28/08
Checked By	DRA	10/28/08
Approved By		

Project Number	040-007
Drawing Number	040-007-A474

5g

Figure

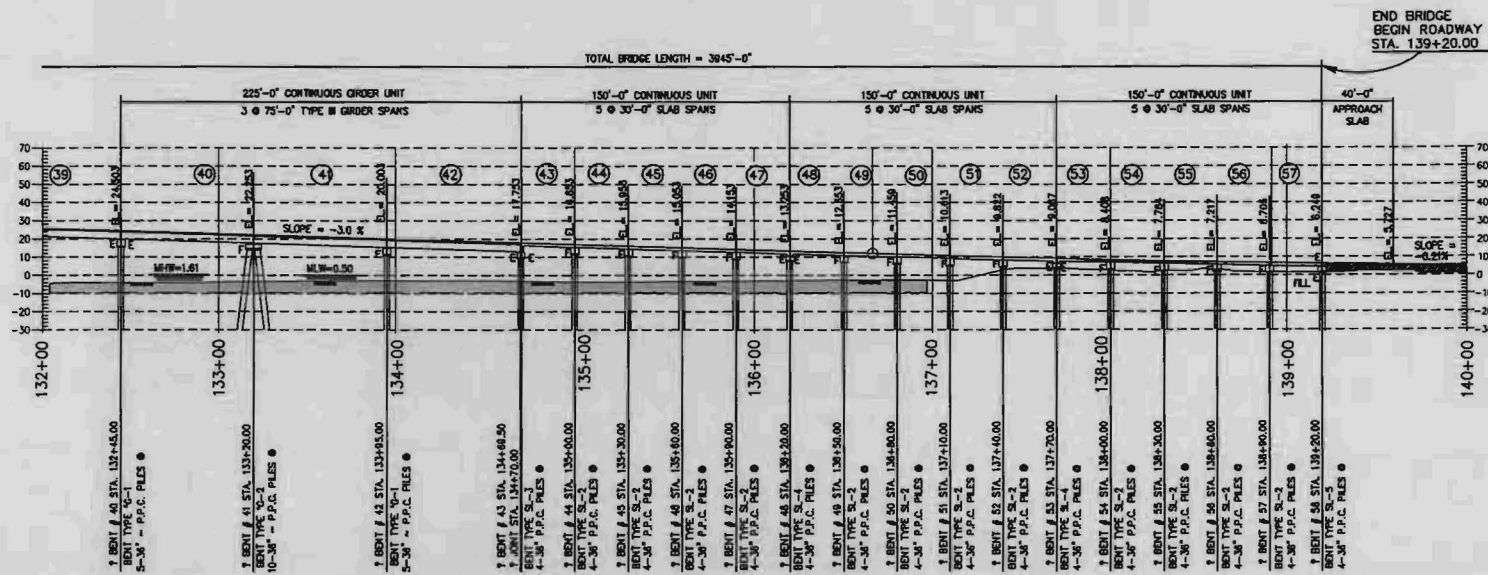

## Legend

- Proposed Area To Be Dredged
- Construction of New Bridge = 59,100 yds<sup>3</sup>
- Removal of Old Bridge = 15,700 yds<sup>3</sup>
- Maintenance Dredging = 7,500 yds<sup>3</sup>
- TOTAL = 82,300 yds<sup>3</sup>

## Notes

1. Fill associated with the proposed project will consist of the displacement of 12,800 yd<sup>3</sup> of non-vegetated water bottoms associated with the setting of bridge piles.
2. All fill associated with dredged water bottoms will be hauled offsite.
3. Concrete associated with construction of new bridge 11,192 yd<sup>3</sup>.
4. Crushed stone fill associated with approaches to new bridge 1,989 yd<sup>3</sup>.

100 0 100

Scale: 1" = 100'

## Reference

Base drawing provided by client.

**Profile View A-A'**  
**Caminada Bay Bridge**  
Coastal Use Permit  
SPN 064-01-0040/FAP BR-52-01(001)  
Jefferson Parish, Louisiana

Louisiana  
Department of Transportation and Development



**PROVIDENCE**


Drawn By	LMM	09/29/08
Checked By	DRA	09/29/08
Approved By		

Project Number	040-007
Drawing Number	040-007-A338

5e

Figure



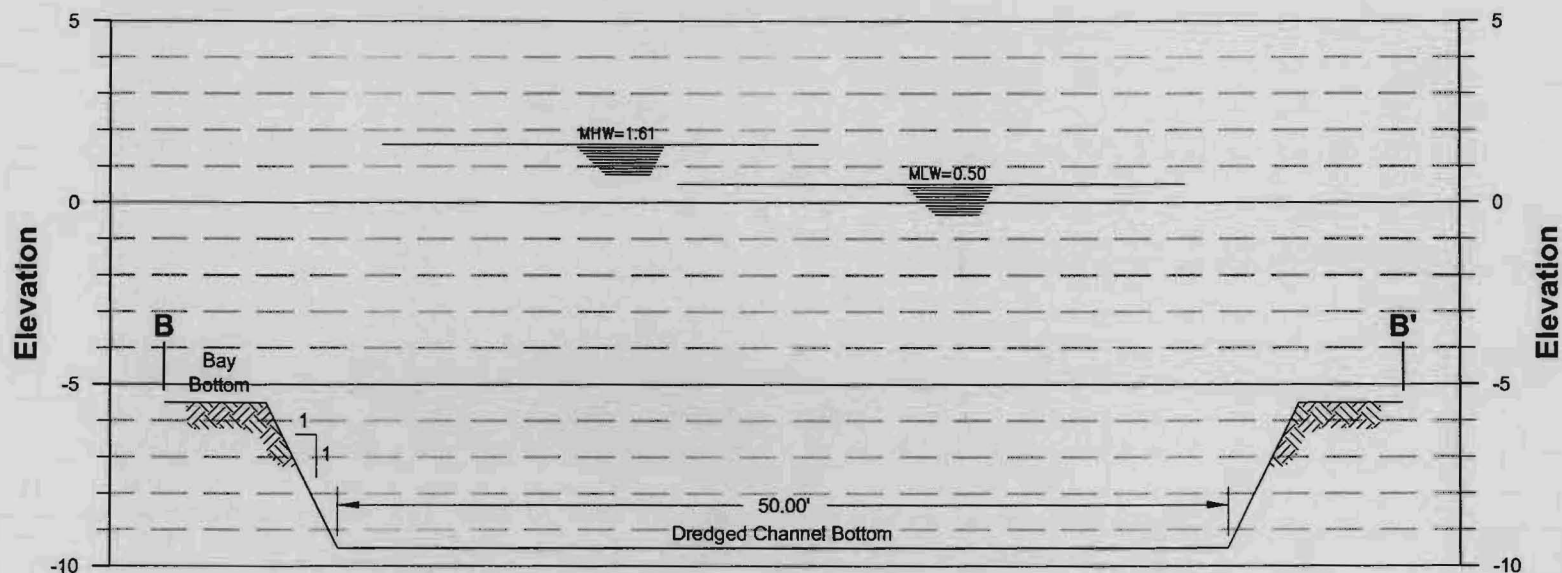


### Section B-B'

Horizontal Scale: 1" = 10'

Vertical Scale: 1" = 5'

### Notes

1. Dredging for Construction of New Bridge = 59,100 yd<sup>3</sup>
2. Dredging for Removal of Old Bridge = 15,700 yd<sup>3</sup>
3. Maintenance Dredging During Construction Period = 7,500 yd<sup>3</sup>  
(10% of Total Dredging)
4. All fill associated with dredged water bottoms will be hauled offsite.

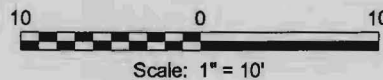

### Cross Section B-B' Caminada Bay Bridge

Coastal Use Permit

SPN 064-01-0040/FAP BR-52-01(001)

Jefferson Parish, Louisiana

Louisiana  
Department of Transportation and Development



PROVIDENCE


Drawn By	LMM	10/01/08
Checked By	DRA	10/01/08
Approved By		

Project Number  
040-007

Drawing Number  
040-007-A383

**6a**

Figure

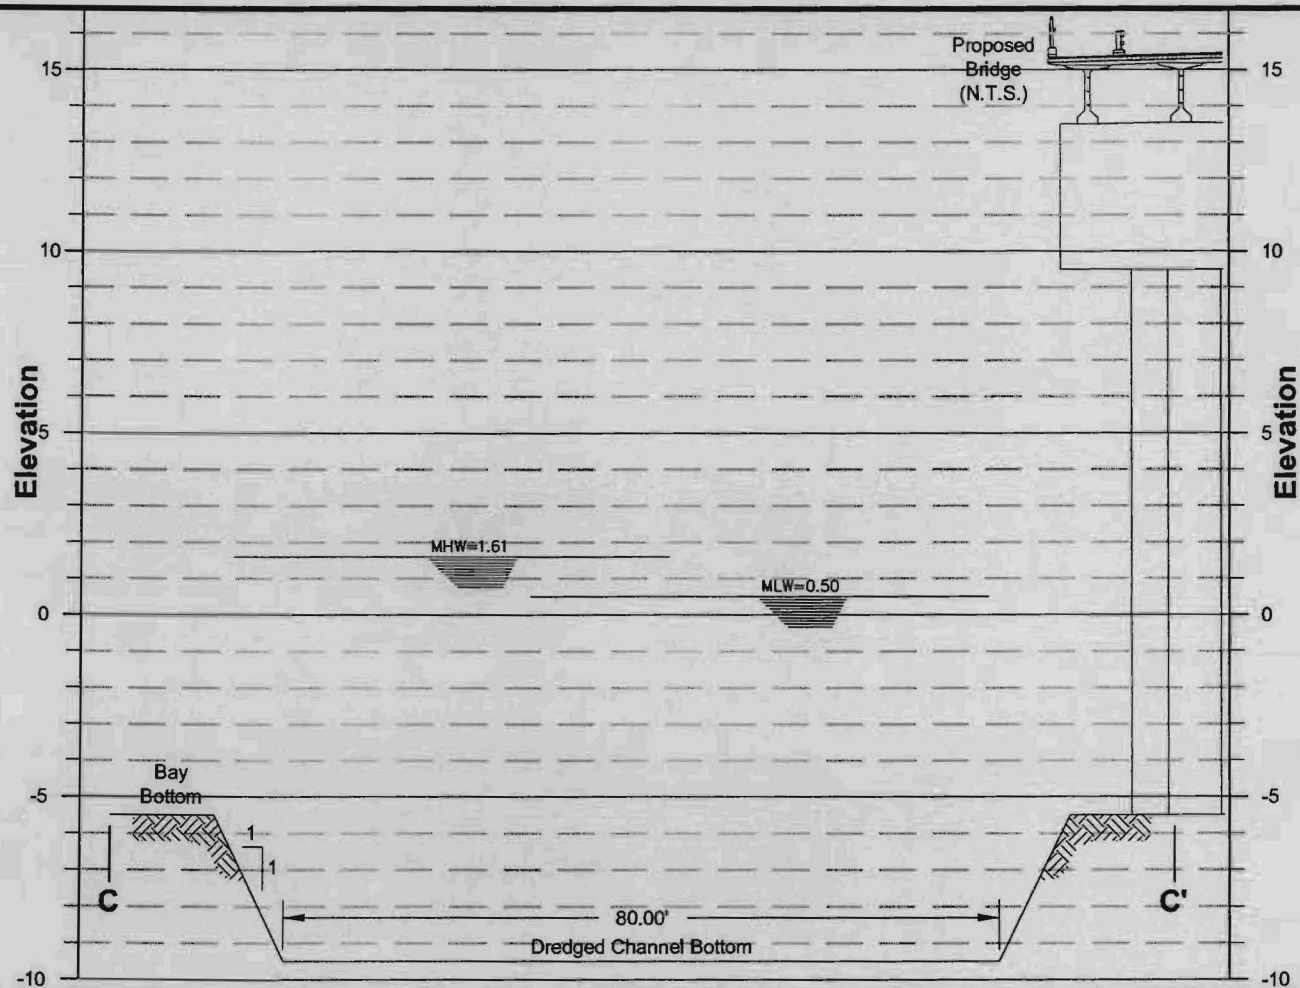


### Notes

1. Dredging for Construction of New Bridge = 59,100 yd<sup>3</sup>
2. Dredging for Removal of Old Bridge = 15,700 yd<sup>3</sup>
3. Maintenance Dredging During Construction Period = 7,500 yd<sup>3</sup>  
(10% of Total Dredging)
4. All fill associated with dredged water bottoms will be hauled offsite.

### Section C-C'

Horizontal Scale: 1" = 20'  
Vertical Scale: 1" = 5'

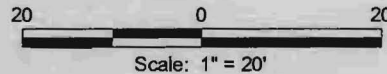


### Cross Section C-C' Caminada Bay Bridge Coastal Use Permit SPN 064-01-0040/FAP BR-52-01(001) Jefferson Parish, Louisiana

Louisiana  
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Drawn By	LMM	10/13/08
Checked By	DRA	10/13/08
Approved By		
Project Number	040-007	
Drawing Number	040-007-A427	

**6b**  
Figure




### Notes

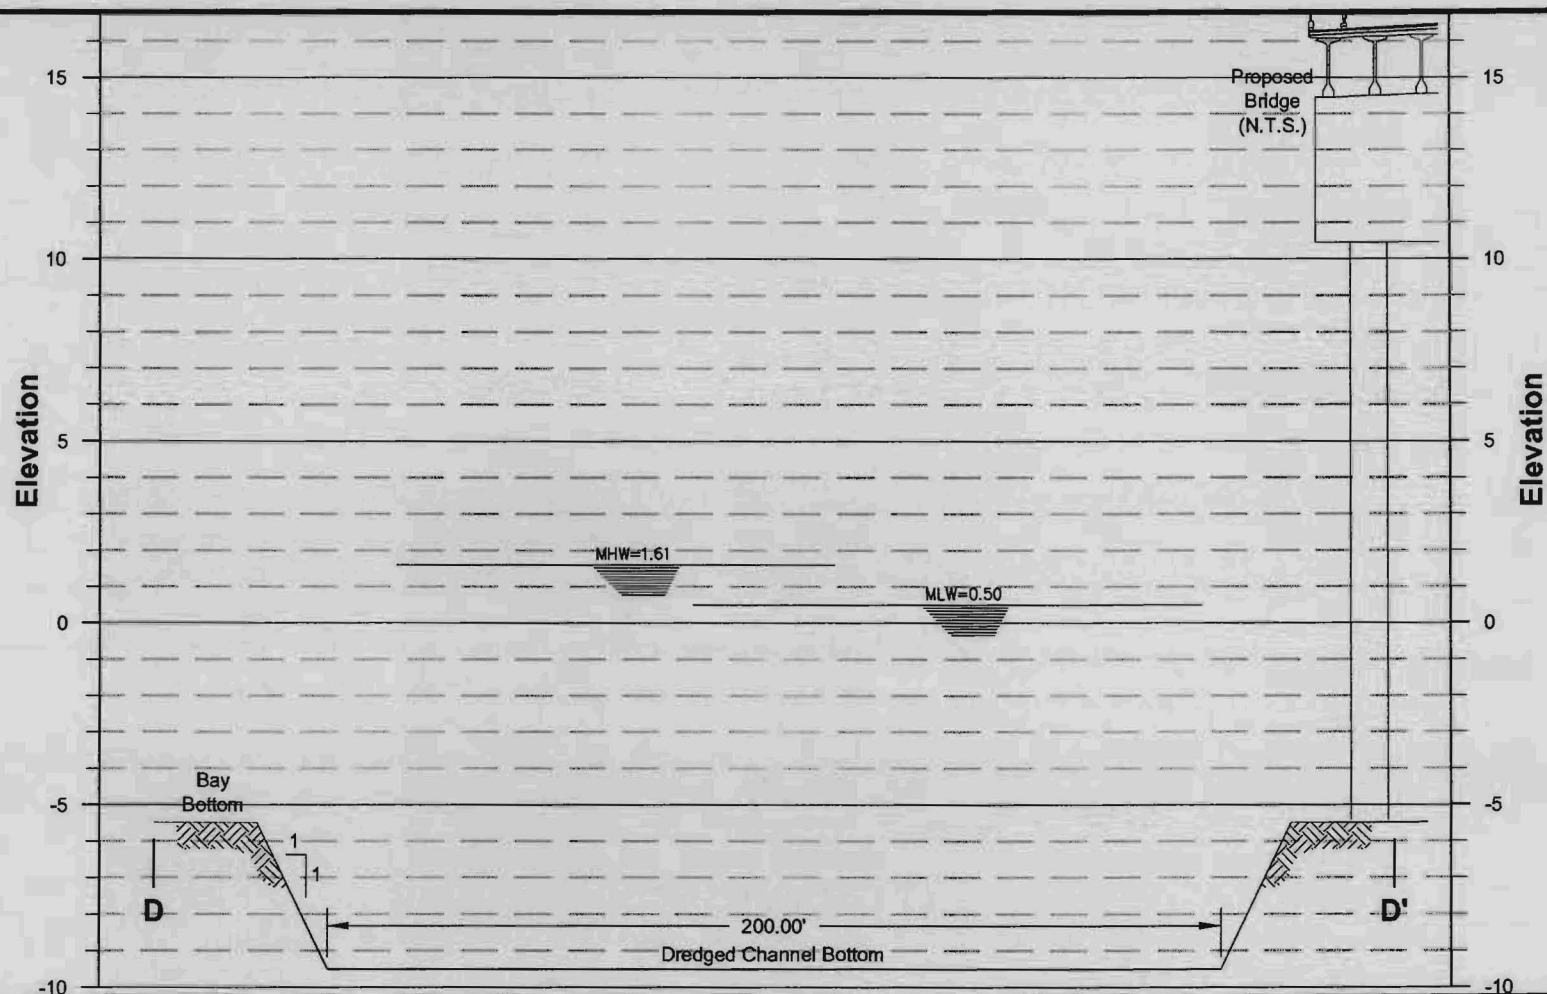1. Dredging for Construction of New Bridge = 59,100 yd<sup>3</sup>
2. Dredging for Removal of Old Bridge = 15,700 yd<sup>3</sup>
3. Maintenance Dredging During Construction Period = 7,500 yd<sup>3</sup>  
(10% of Total Dredging)
4. All fill associated with dredged water bottoms will be hauled offsite.

### Section D-D'

Horizontal Scale: 1" = 40'  
Vertical Scale: 1" = 5'

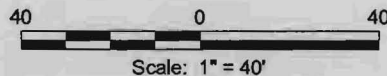


### Cross Section D-D' Caminada Bay Bridge

Coastal Use Permit  
SPN 064-01-0040/FAP BR-52-01(001)  
Jefferson Parish, Louisiana

Louisiana  
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Drawn By	LMM	10/13/08
Checked By	DRA	10/13/08
Approved By		
Project Number	040-007	<b>6c</b> Figure
Drawing Number	040-007-A428	




### Notes

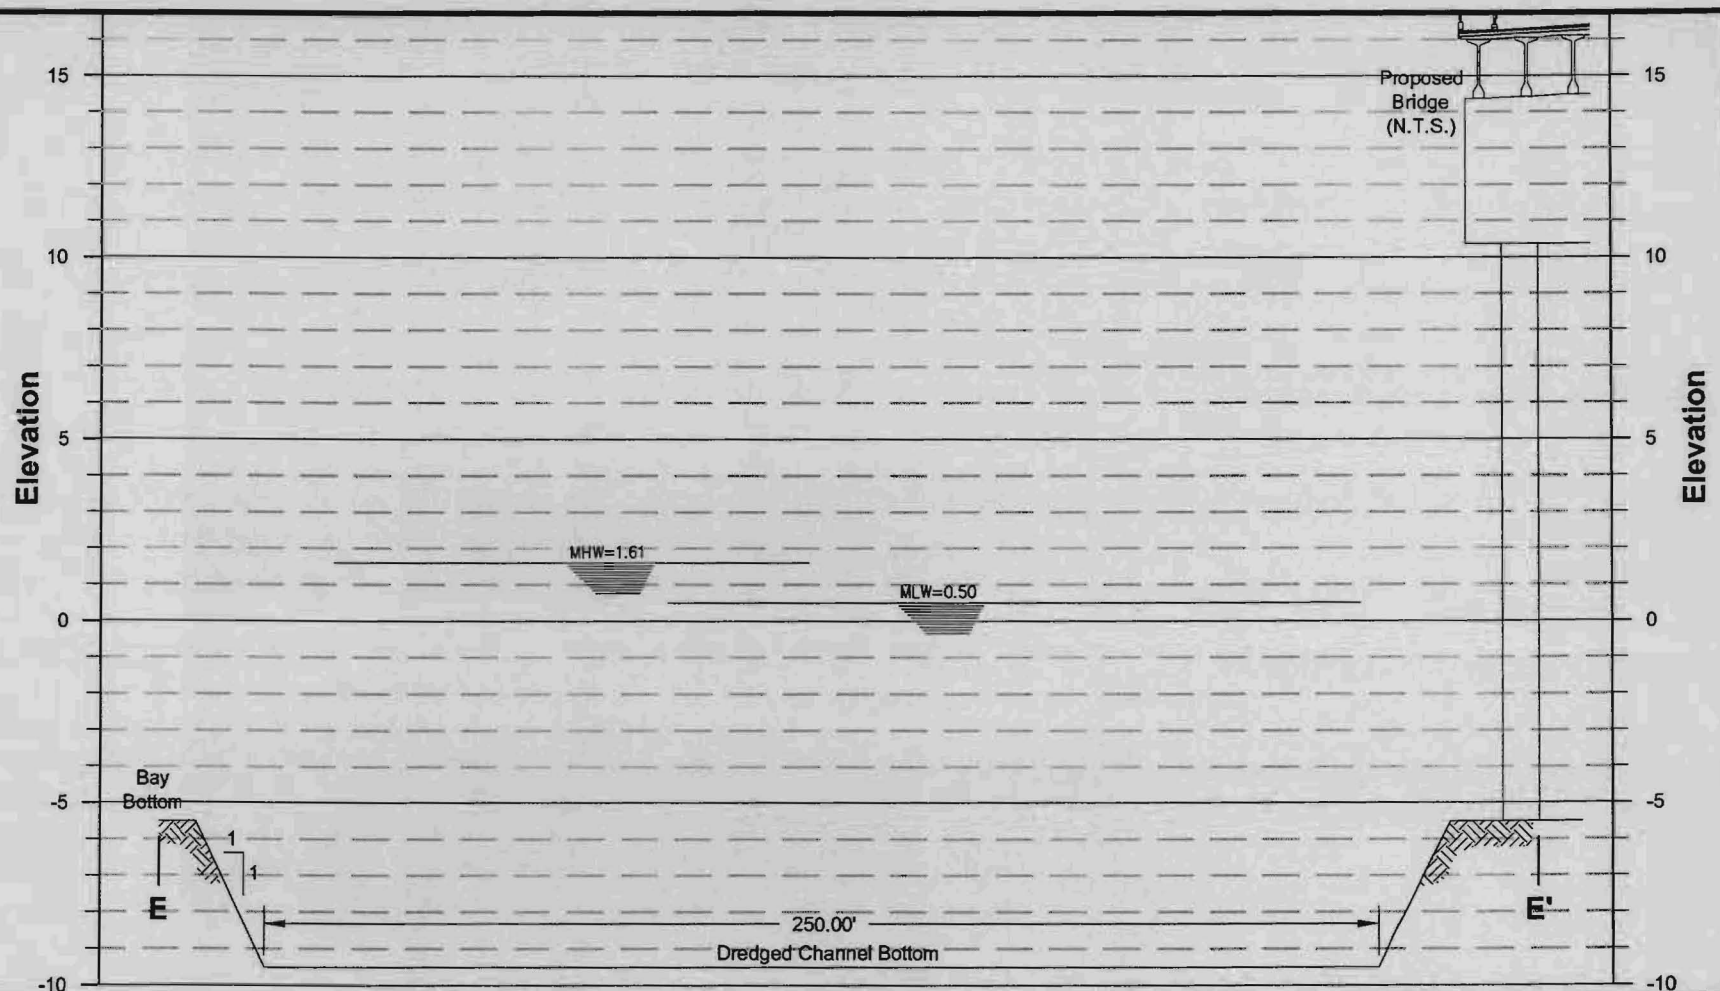1. Dredging for Construction of New Bridge = 59,100 yd<sup>3</sup>
2. Dredging for Removal of Old Bridge = 15,700 yd<sup>3</sup>
3. Maintenance Dredging During Construction Period = 7,500 yd<sup>3</sup>  
(10% of Total Dredging)
4. All fill associated with dredged water bottoms will be hauled offsite.

### Section E-E'

Horizontal Scale: 1" = 40'  
Vertical Scale: 1" = 5'

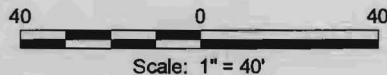

**Cross Section E-E'**  
**Caminada Bay Bridge**  
Coastal Use Permit  
SPN 064-01-0040/FAP BR-52-01(001)  
Jefferson Parish, Louisiana


**Louisiana**  
**Department of Transportation and Development**



Drawn By	LMM	10/13/08
Checked By	DRA	10/13/08
Approved By		
Project Number	040-007	
Drawing Number	040-007-A429	

**6d**  
Figure



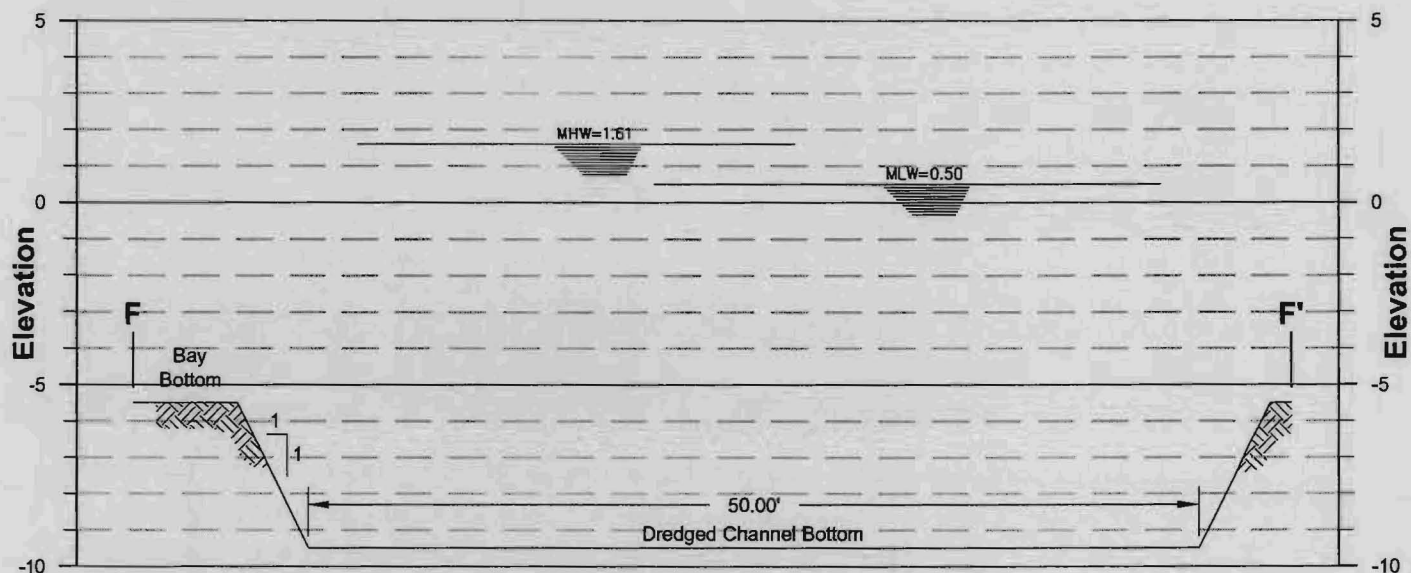


### Section F-F'

Horizontal Scale: 1" = 10'  
Vertical Scale: 1" = 5'

### Notes

1. Dredging for Construction of New Bridge = 59,100 yd<sup>3</sup>
2. Dredging for Removal of Old Bridge = 15,700 yd<sup>3</sup>
3. Maintenance Dredging During Construction Period = 7,500 yd<sup>3</sup>  
(10% of Total Dredging)
4. All fill associated with dredged water bottoms will be hauled offsite.

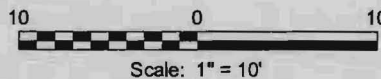


### Cross Section F-F' Caminada Bay Bridge Coastal Use Permit SPN 064-01-0040/FAP BR-52-01(001) Jefferson Parish, Louisiana

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Drawn By	LMM	10/13/08
Checked By	DRA	10/13/08
Approved By		
Project Number	040-007	
Drawing Number	040-007-A430	

**6e**  
Figure




### Notes

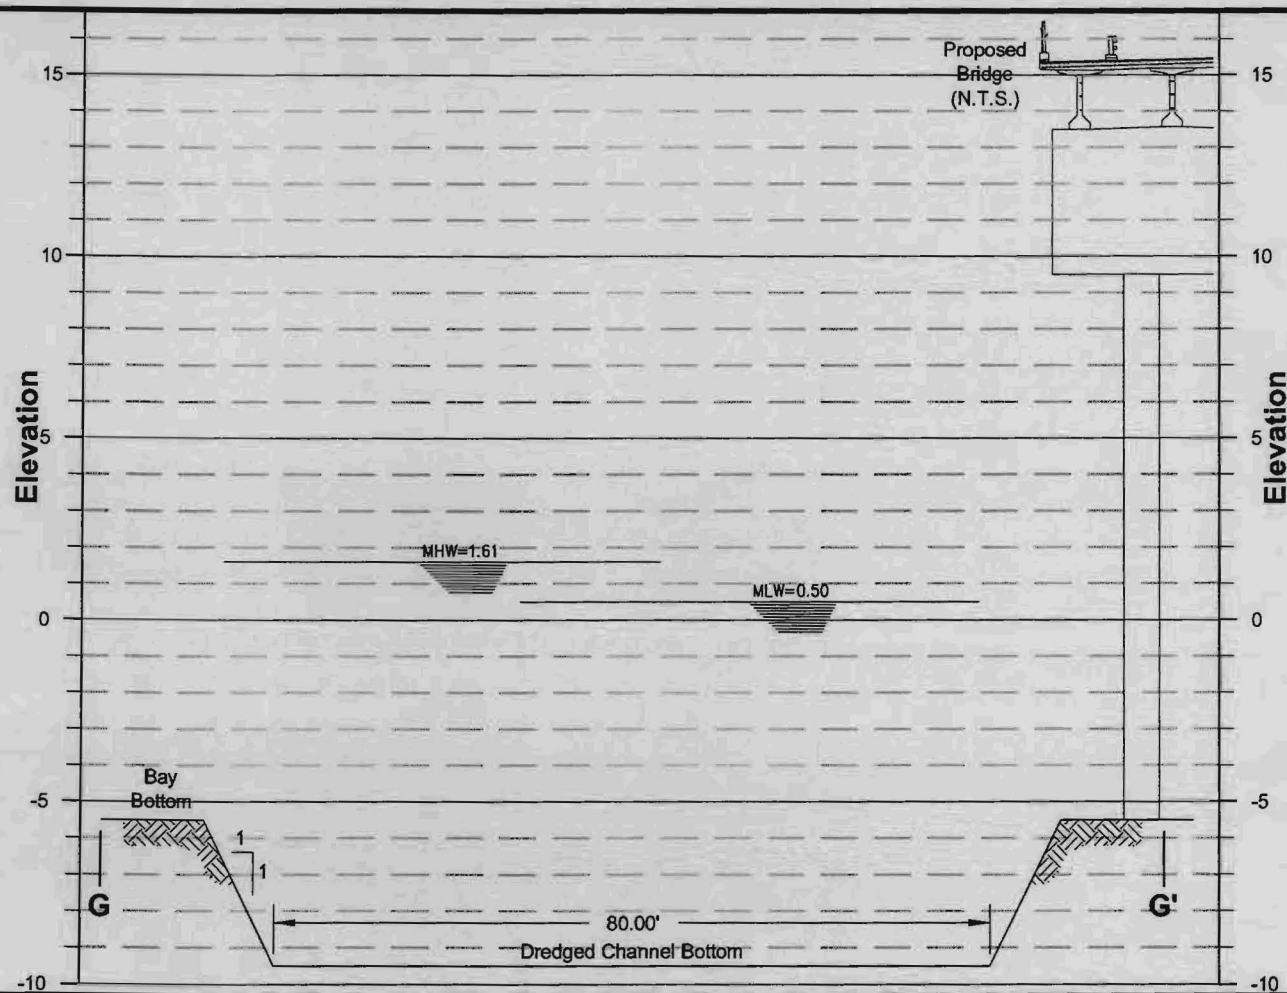1. Dredging for Construction of New Bridge = 59,100 yd<sup>3</sup>
2. Dredging for Removal of Old Bridge = 15,700 yd<sup>3</sup>
3. Maintenance Dredging During Construction Period = 7,500 yd<sup>3</sup>  
(10% of Total Dredging)
4. All fill associated with dredged water bottoms will be hauled offsite.

### Section G-G'

Horizontal Scale: 1" = 20'  
Vertical Scale: 1" = 5'

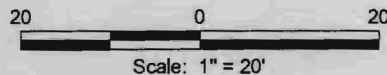

### Cross Section G-G' Caminada Bay Bridge


Coastal Use Permit  
SPN 064-01-0040/FAP BR-52-01(001)  
Jefferson Parish, Louisiana

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Drawn By	LMM	10/13/08
Checked By	DRA	10/13/08
Approved By		
Project Number	040-007	<b>6f</b> Figure
Drawing Number	040-007-A431	






**Typical Section - Overlay**  
**Applies Sta. 98+48 to Sta. 99+24**  
**Applies Sta. 139+40 to Sta. 140+72**

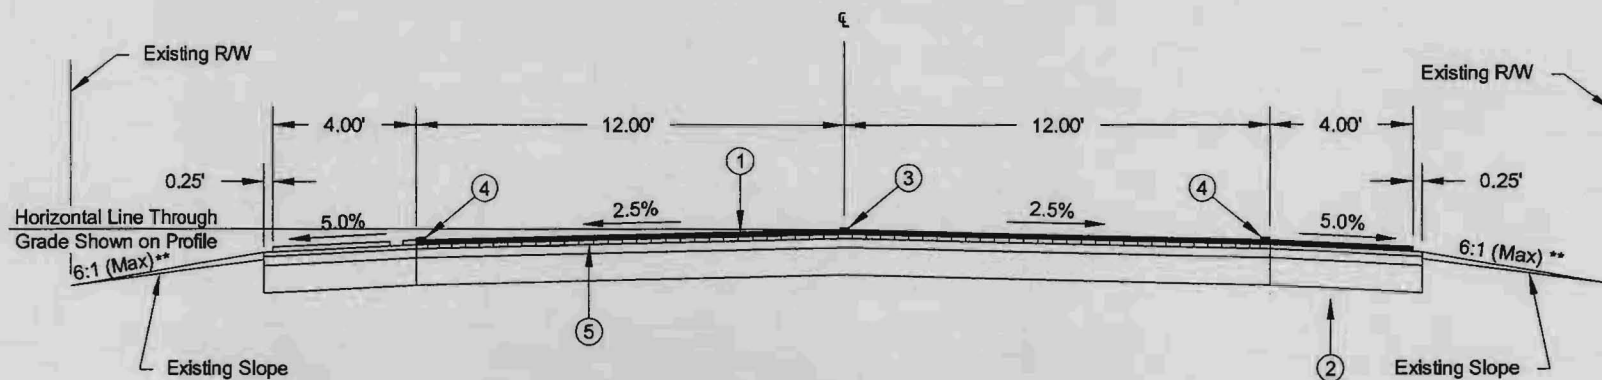Scale: 1" = 5'

### Legend

- ① 6" Superpave Asphaltic Concrete Wearing and Binder Course (222 yd³)
- ② 10" Class 2 Base Course (1,989.9 yd³ Crushed Stone)
- ③ Pavement Striping and Reflectorized Markers
- ④ Pavement Striping
- ⑤ 6" Cold Planing (1,115.18 yd³)

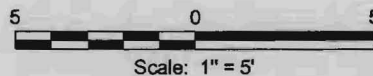

### Typical Section of Approach Caminada Bay Bridge

Coastal Use Permit  
SPN 064-01-0040/FAP BR-52-01(001)  
Jefferson Parish, Louisiana

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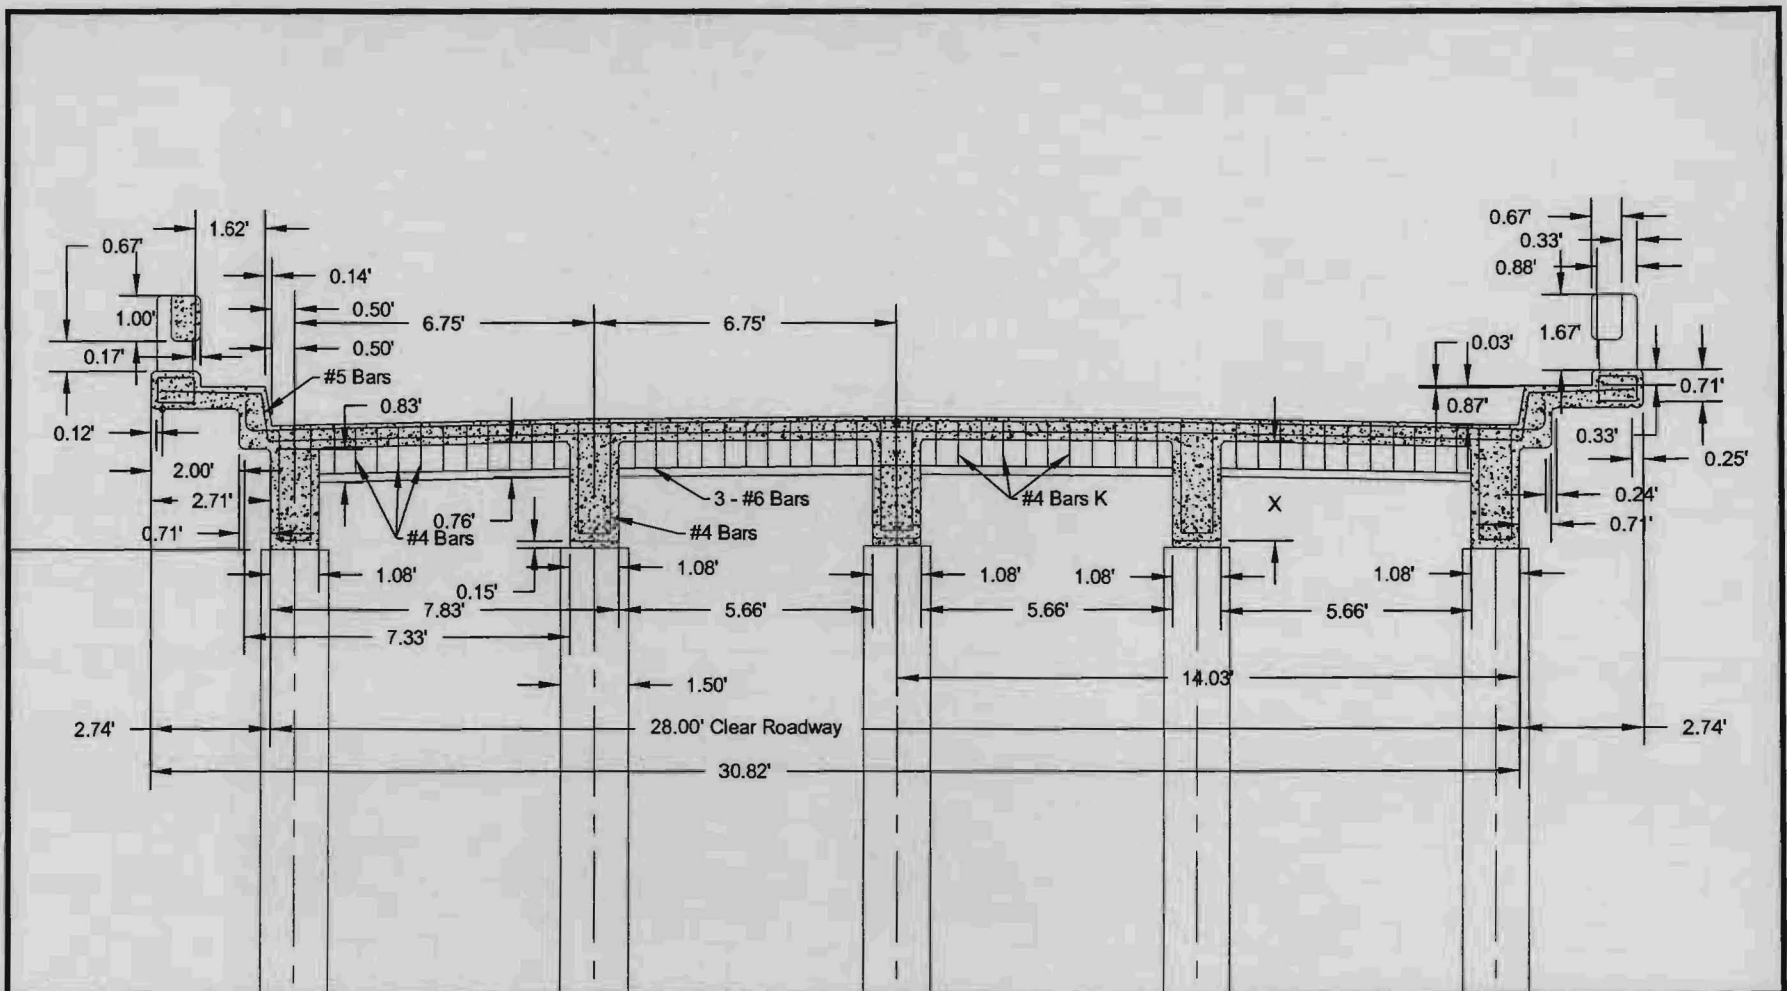


PROVIDENCE

Drawn By	LMM	10/23/08
Checked By	DRA	10/23/08
Approved By		
Project Number	040-007	
Drawing Number	040-007-A471	

**7b**  
Figure






### Notes

1. Construction of the new bridge will consist of the excavation of 59,100 yd<sup>3</sup> of non-vegetated water bottoms.
2. Concrete from the removal of the existing bridge 7,500 yd<sup>3</sup>.

### Existing Bridge Section

Scale: 1" = 4'

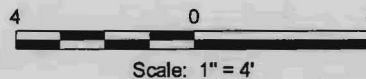


### Existing Bridge Section Caminada Bay Bridge

Coastal Use Permit  
SPN 064-01-0040/FAP BR-52-01(001)  
Jefferson Parish, Louisiana

Louisiana  
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Drawn By	LMM	10/23/08
Checked By	DRA	10/23/08
Approved By		
Project Number 040-007		<b>7c</b> Figure
Drawing Number 040-007-A472		




### Notes

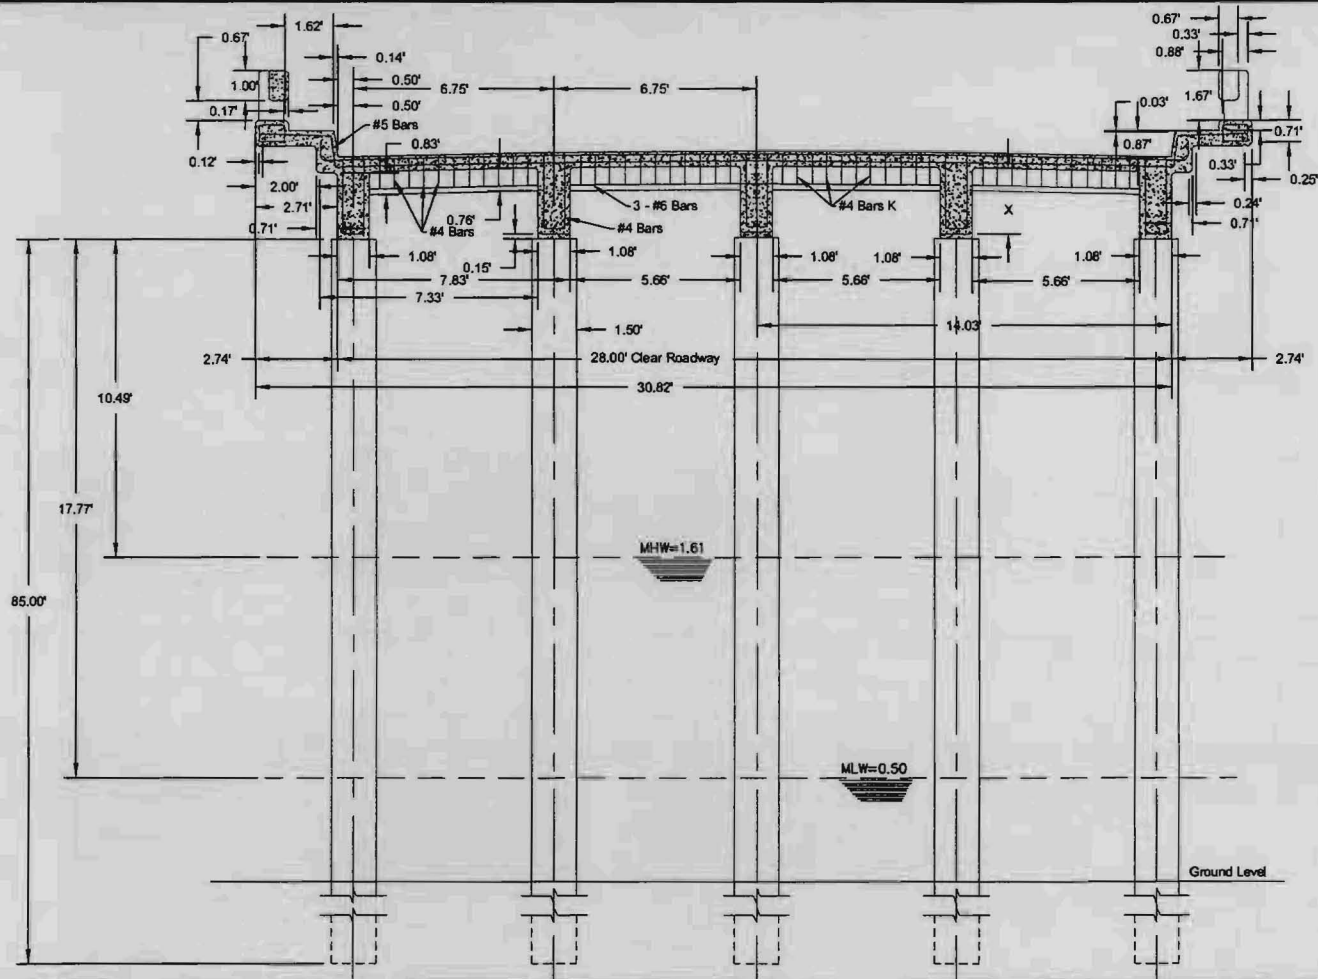1. Construction of the new bridge will consist of the excavation of 59,100 yd<sup>3</sup> of non-vegetated water bottoms.
2. Concrete from the removal of the existing bridge 7,500 yd<sup>3</sup>.

### Existing Bridge Section

Scale: 1" = 6'

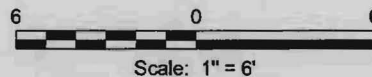

### Existing Bridge Section Caminada Bay Bridge

Coastal Use Permit  
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Jefferson Parish, Louisiana


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Department of Transportation and Development



PROVIDENCE

Drawn By	LMM	11/07/08
Checked By	DRA	11/07/08
Approved By		
Project Number	040-007	
Drawing Number	040-007-A488	

**7d**  
Figure

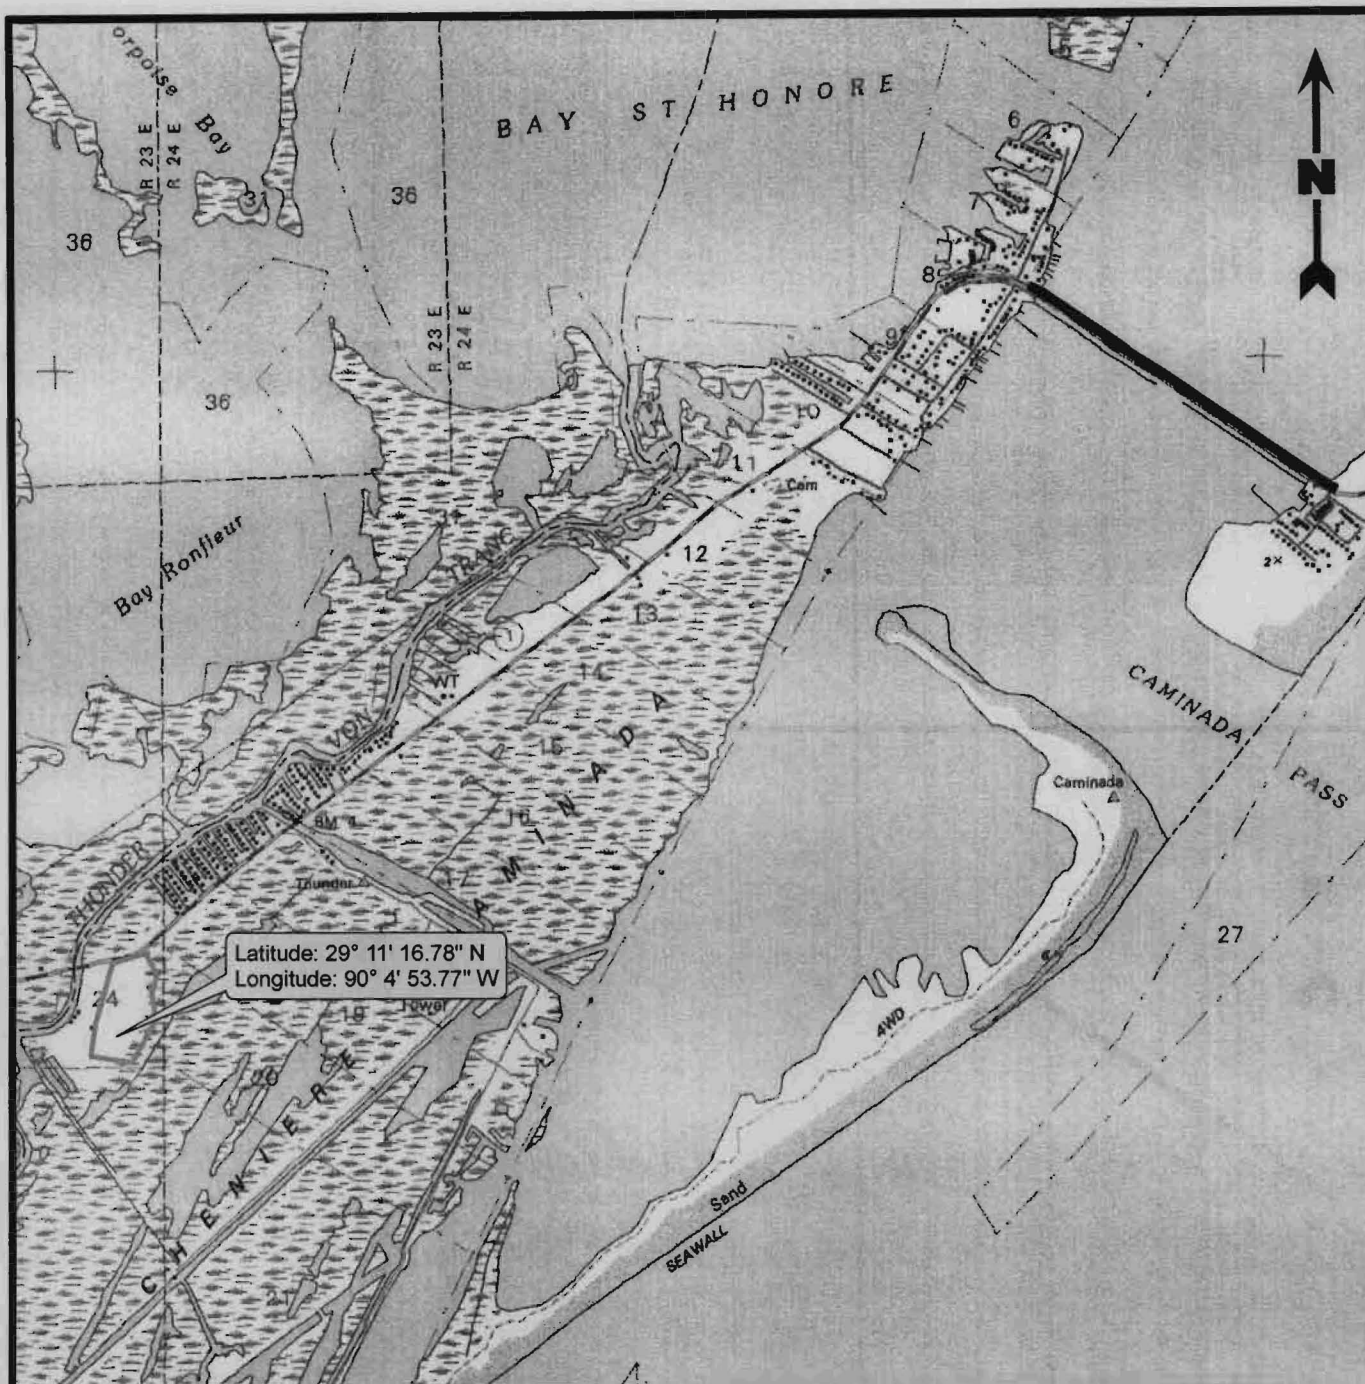

2,000 1,000 0 2,000  
Feet

#### Legend

- Project Area (8.62 Acres)
- Potential Disposal Site (14.01 Acres)

#### Reference

Base map comprised of U.S.G.S. 7.5 minute topographic map, "Caminada Pass, LA" and "Bay Tambour, LA" 1994.

### Site Disposal Map Caminada Bay Bridge

Coastal Use Permit  
SPN 064-01-0040/FAP BR-52-01(001)  
Jefferson Parish, Louisiana

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Drawn By	LMM	12/19/08
Checked By	DRA	12/19/08
Approved By		

Project Number  
040-007

Drawing Number  
040-007-A537

**8a**  
Figure



400 200 0 400  
Feet

### Legend

 Proposed Fill Area (14.01 Acres)

### Reference

Base map comprised of 2007 aerial photography.

## Aerial of Site Disposal Area

### Caminada Bay Bridge

Coastal Use Permit

SPN 064-01-0040/FAP BR-52-01(001)

Jefferson Parish, Louisiana

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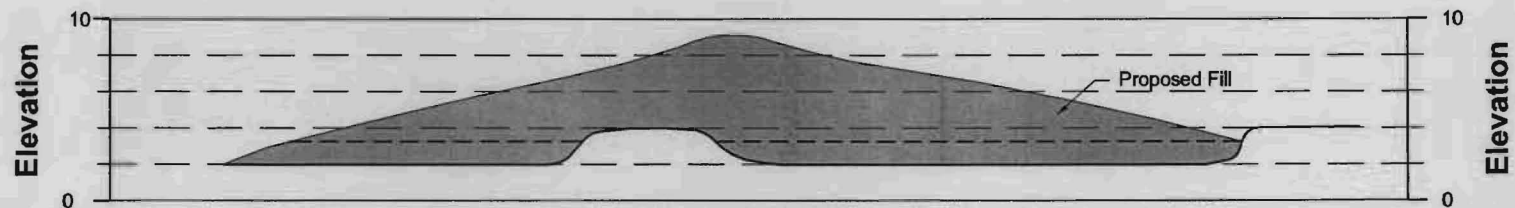
Drawn By	LMM	12/19/08
Checked By	DRA	12/19/08
Approved By		

Project Number  
040-007

Drawing Number  
040-007-A536

**8b**  
Figure






### Cross Section

Horizontal Scale: 1" = 10'

Vertical Scale: 1" = 10'

### Note

Proposed Fill = 82,300 yd<sup>3</sup>

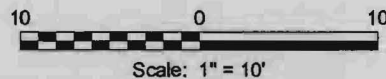

### **Site Disposal Area Cross Section Caminada Bay Bridge**

Coastal Use Permit  
SPN 064-01-0040/FAP BR-52-01(001)  
Jefferson Parish, Louisiana

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**PROVIDENCE**

Drawn By	LMM	12/19/08
Checked By	DRA	12/19/08
Approved By		
Project Number	040-007	<b>8c</b> Figure
Drawing Number	040-007-A535	